

PROJECT:

# OGDEN REGIONAL CENTER - ELEVATOR MODERNIZATION

2535 WASHINGTON BOULEVARD, OGDEN, UTAH




State of Utah—Department of Administrative Services

**DIVISION OF FACILITIES CONSTRUCTION AND MANAGEMENT**

4110 State Office Building/Salt Lake City, Utah 84114/538-3018

**DFCM PROJECT NO. 09071310**  
**DFCM CONTRACT NO. 0974998**

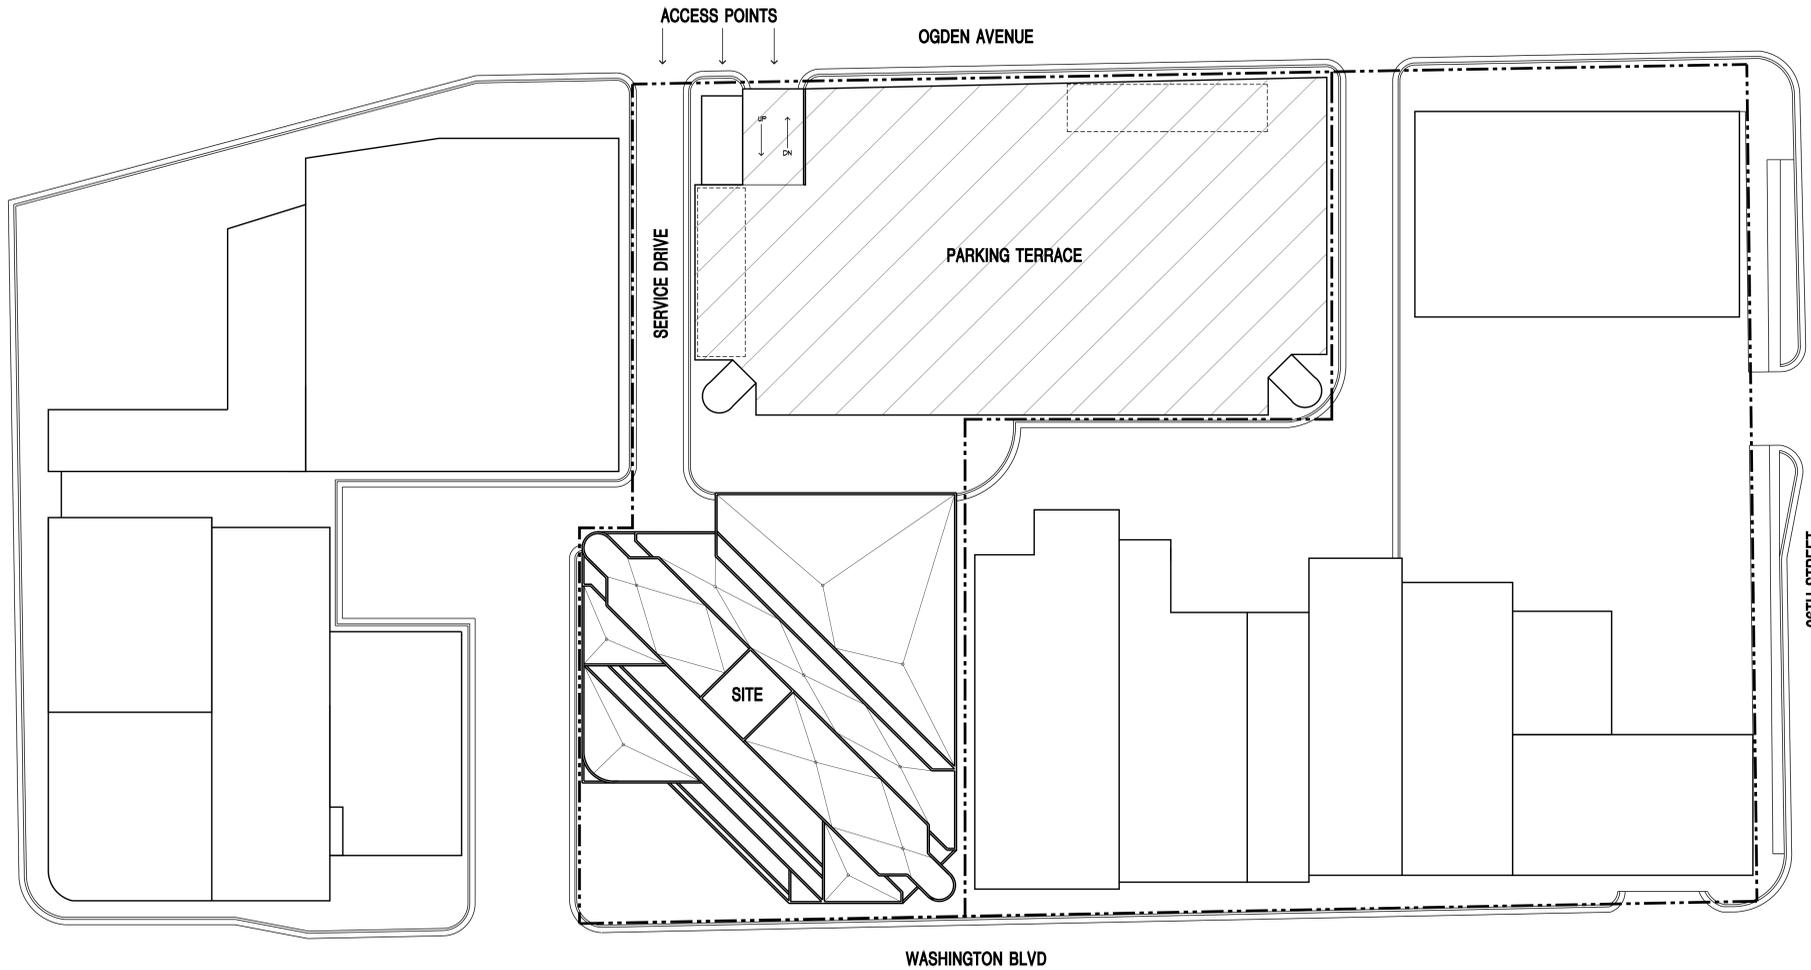

*architects*  
*planners*  
*interior designers*

6465 South 3000 East  
Suite 205  
Salt Lake City, UT 84121  
Ph: 801.733-2500  
Fax: 801.733-2501  
www.jsa-llc.com

CREATED BY: JSA ARCHITECTS

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CONSULTANT:

BUILDING NAME:

**OGDEN REGIONAL CENTER**

PROJECT TITLE:

**OGDEN REGIONAL CENTER  
ELEVATOR  
MODERNIZATION**

**2540 WASHINGTON  
BOULEVARD  
OGDEN, UTAH 84401**

ISSUE TYPE: CONSTRUCTION SET

MARK	DATE	DESCRIPTION
XX-XX-XX	XXX	

ISSUE DATE: SEPTEMBER 14, 2009

DFCM PROJECT NO:	09071310
CAD PROJECT NO:	09034
CAD DWG FILE:	
DRAWN BY:	MLJ
CHK'D BY:	
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SHEET TITLE

**COVER SHEET**

SHEET NUMBER


**G-001**

SHEET 01 OF 18

PROJECT TEAM		ARCHITECT	INTERIOR DESIGNER	CIVIL ENGINEER	STRUCTURAL ENGINEER	MECHANICAL ENGINEER	ELECTRICAL ENGINEER	LANDSCAPE ARCHITECT	GENERAL CONTRACTOR																																																																																																																																																																																																					
		<b>JSA ARCHITECTS, LLC</b> 6465 SOUTH 3000 EAST SUITE 205 SALT LAKE CITY, UTAH 84121 PHONE: (801) 733-2500	-	-	-	-	<b>ELECTRICAL CONSULTING ENGINEERS</b> 939 SOUTH WEST TEMPLE SALT LAKE CITY, UTAH 84101 PHONE: (801) 521-8201	-	-																																																																																																																																																																																																					
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MARK	DATE	DESCRIPTION
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ISSUE TYPE: CONSTRUCTION SET


ISSUE DATE: SEPTEMBER 14, 2009

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 CHK'D BY:  
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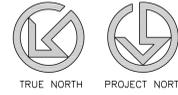
SHEET TITLE  
**SITE PLAN**

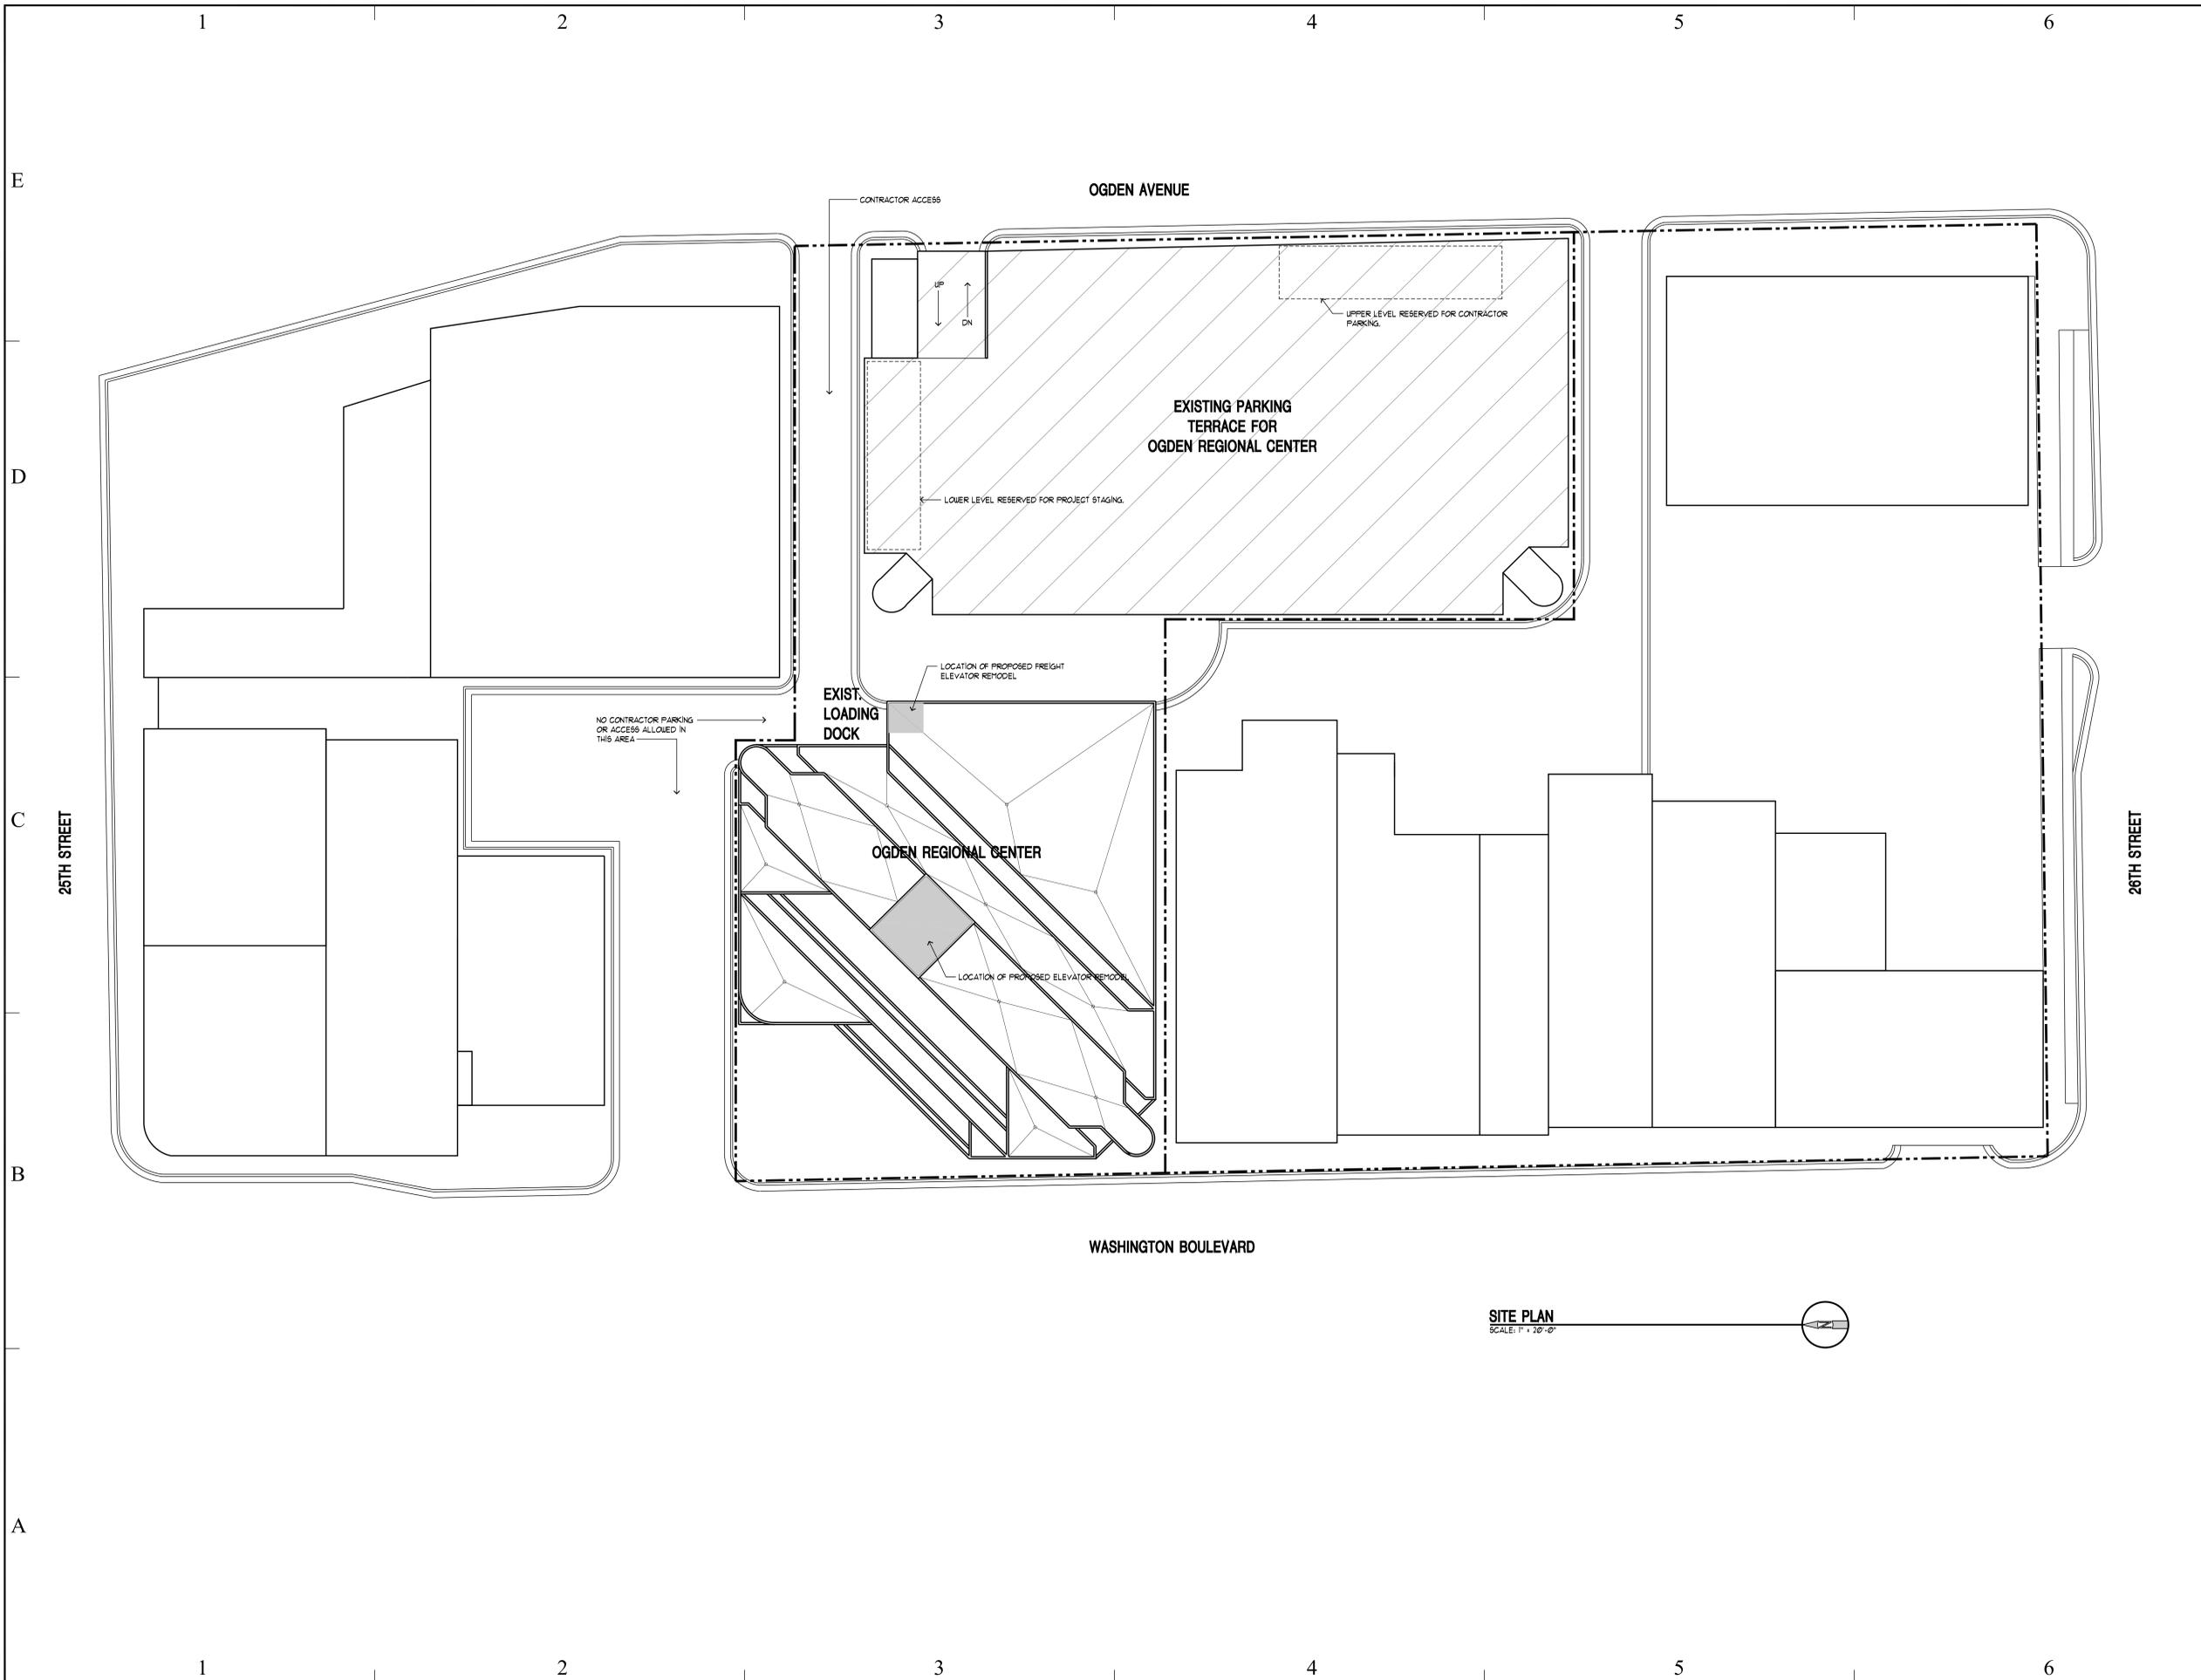SHEET NUMBER  
**A-101**


SHEET 03 OF 18

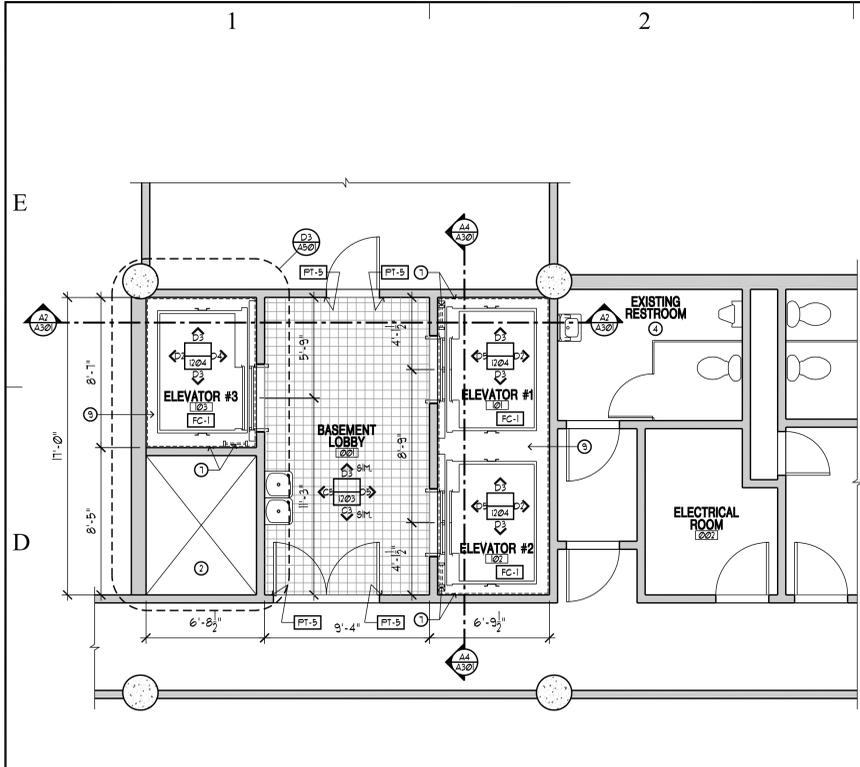



**BASEMENT FLOOR PLAN**  
SCALE: 1/4" = 1'-0"  
C2  
A-102





NOTE:  
SEE SHEET 1204 FOR FINISH SCHEDULE

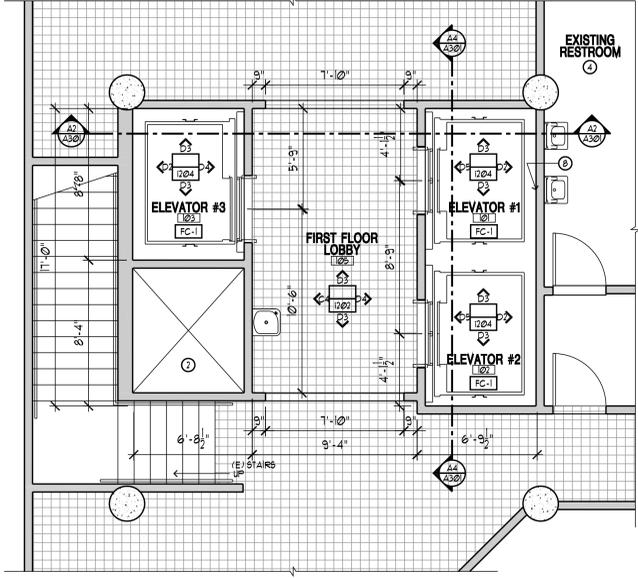


**FIRST FLOOR PLAN**  
SCALE: 1/4" = 1'-0"  
C5  
A-102

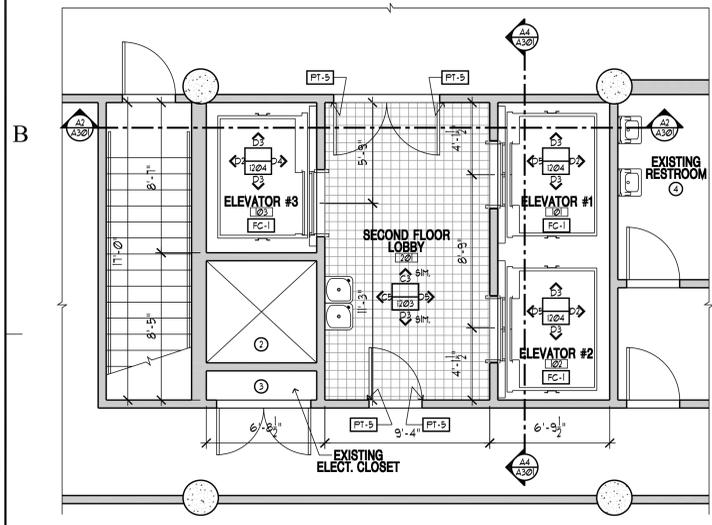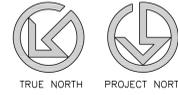


**SECOND FLOOR PLAN**  
SCALE: 1/4" = 1'-0"  
A2  
A-102

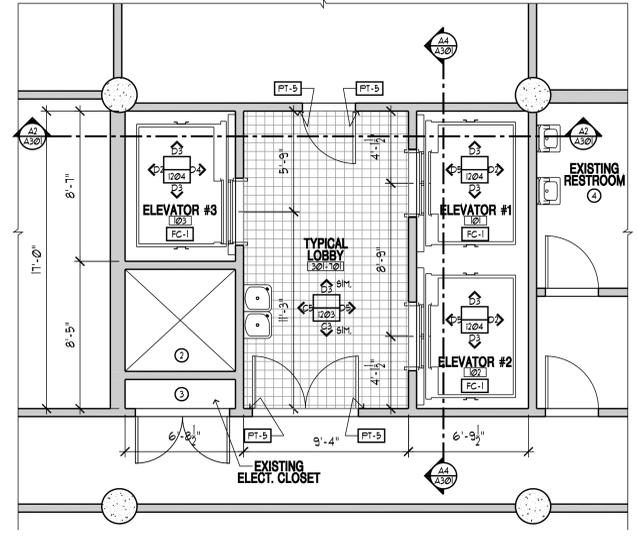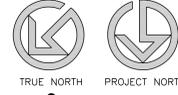

**TYPICAL FLOOR PLAN - LEVELS 3 THRU 7**  
SCALE: 1/4" = 1'-0"  
A4  
A-102

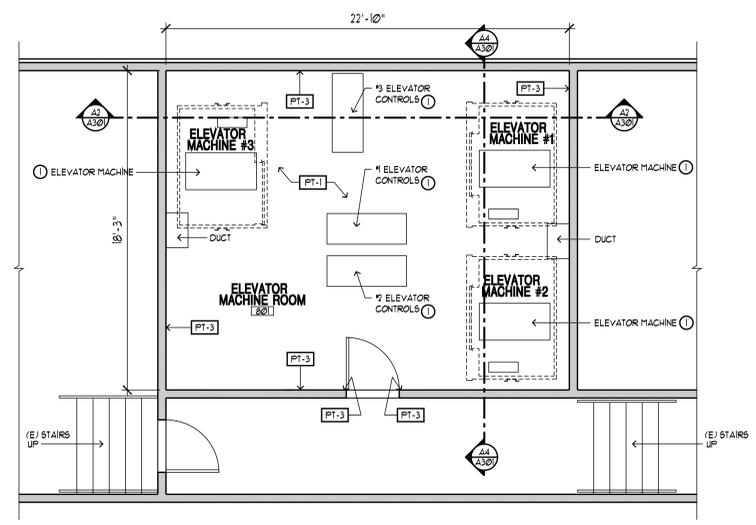

**PENTHOUSE FLOOR PLAN**  
SCALE: 1/4" = 1'-0"  
A6  
A-102

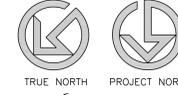

NOTE:  
CONTRACTOR SHALL VERIFY ALL LOCATIONS  
AND DIMENSIONS OF CONTROL RACKS,  
HOISTWAY MACHINES AND VENT DUCTS.

FLOOR PLAN LEGEND		
HATCH PATTERN	SECTION	DESCRIPTION
[Grid Hatch]	000000	EXISTING TILE FLOOR - LOBBY TO REMAIN

FLOOR PLAN KEY NOTES	
SECTION	DESCRIPTION
000000	1 REMOVE EXISTING ELEVATOR EQUIPMENT AND REPLACE WITH NEW - SEE BASE BID AND ALTERNATE NO. 11915 IN SPECS. SEE 02300.
000000	2 EXISTING CHASE TO REMAIN. NO WORK THIS AREA.
000000	3 EXISTING ELECTRICAL CLOSET TO REMAIN. NO WORK THIS AREA.
000000	4 EXISTING RESTROOM TO REMAIN. NO WORK THIS AREA.
000000	5 EXISTING OFFICES TO REMAIN. NO WORK THIS AREA.
000000	6 EXISTING SHOP AREA TO REMAIN. NO WORK THIS AREA.
000000	7 EXISTING ELEVATOR PIT AND LADDER TO REMAIN. CONTRACTOR VERIFY LOCATION OF LADDER.
000000	8 PATCH PREVIOUSLY CUT OUT SECTION OF GYPSUM BOARD ON REAR HOISTWAY WALL.
000000	9 CLEAN ELEVATOR PIT AND REMOVE ACCUMULATED TRASH.

FLOOR PLAN GENERAL NOTES	
1 -	SEE SHEET A02 FOR PROJECT GENERAL NOTES
2 -	COORDINATE WITH ELECTRICAL DRAWINGS FOR ALL LIGHTING, POWER, AND DATA REQUIREMENTS.
3 -	ALL INT. WALLS ARE ASSUMED TO BE 2X6 METAL STUD WALLS UNLESS SHOWN OTHERWISE.



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BUILDING NAME:

**OGDEN REGIONAL CENTER**

**OGDEN REGIONAL CENTER  
ELEVATOR  
MODERNIZATION**

**2540 WASHINGTON  
BOULEVARD  
ODGEN, UTAH 84401**

MARK	DATE	DESCRIPTION
XX-XX-XX	XXX	

ISSUE TYPE: CONSTRUCTION SET

ISSUE DATE: SEPTEMBER 14, 2009

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CAD PROJECT NO: 09034  
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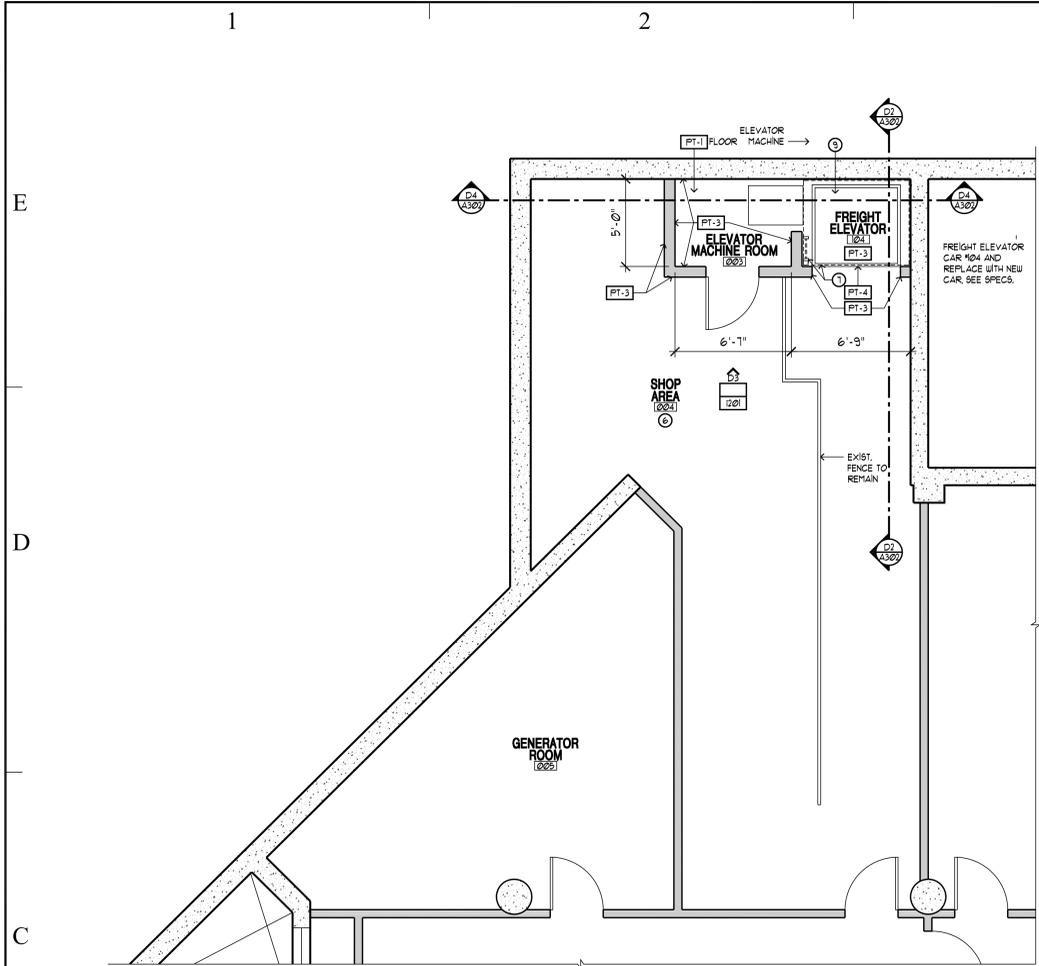
SHEET TITLE

**FLOOR PLANS**

SHEET NUMBER

**A-102**


SHEET 04 OF 18



**BASEMENT FLOOR PLAN**  
SCALE: 1/4" = 1'-0"

C2  
A-103

TRUE NORTH PROJECT NORTH

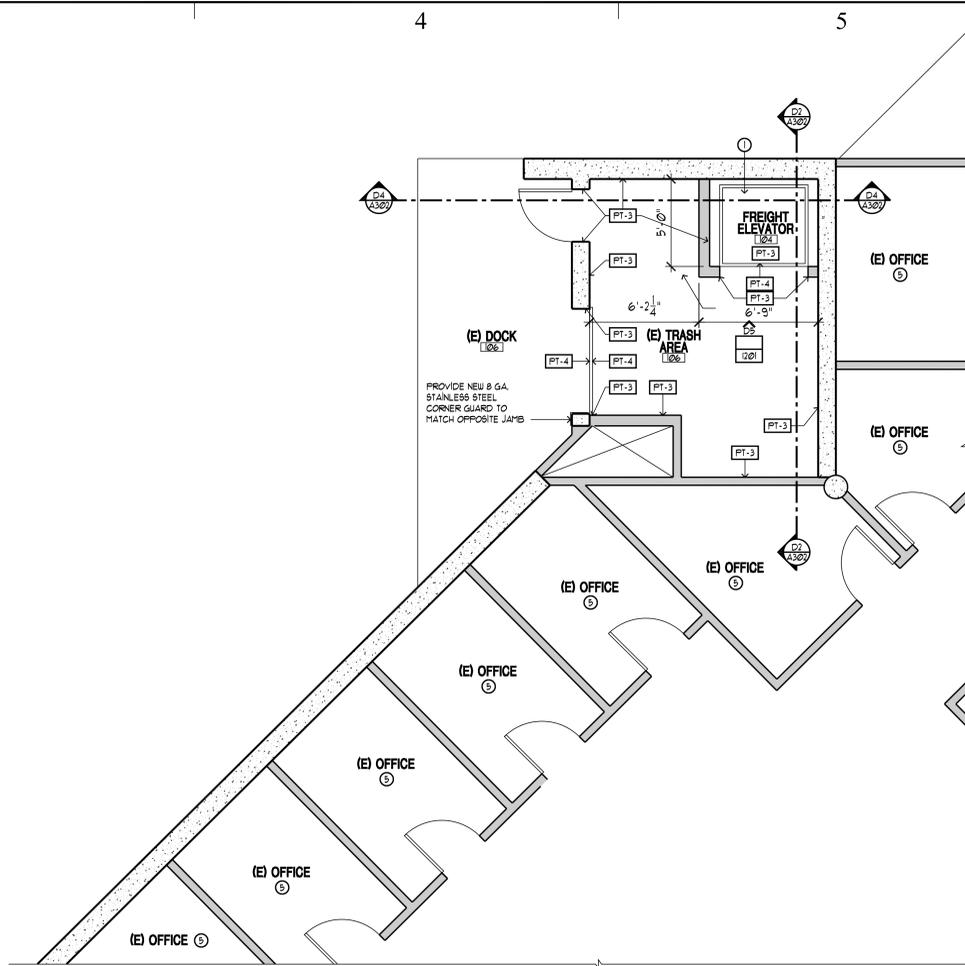

**FIRST FLOOR PLAN**  
SCALE: 1/4" = 1'-0"

C5  
A-103

TRUE NORTH PROJECT NORTH

FLOOR PLAN LEGEND	
HATCH PATTERN	DESCRIPTION
[Grid Pattern]	EXISTING TILE FLOOR - LOBBY TO REMAIN

FLOOR PLAN KEY NOTES	
SECTION	DESCRIPTION
000000	1 REMOVE EXISTING ELEVATOR EQUIPMENT AND REPLACE WITH NEW.
000000	2 EXISTING CHASE TO REMAIN. NO WORK THIS AREA.
000000	3 EXISTING ELECTRICAL CLOSET TO REMAIN. NO WORK THIS AREA.
000000	4 EXISTING RESTROOM TO REMAIN. NO WORK THIS AREA.
000000	5 EXISTING OFFICES TO REMAIN. NO WORK THIS AREA.
000000	6 EXISTING SHOP AREA TO REMAIN. NO WORK THIS AREA.
000000	7 EXISTING ELEVATOR PIT AND LADDER TO REMAIN. CONTRACTOR VERIFY LOCATION OF LADDER.
000000	8 PATCH PREVIOUSLY CUT OUT SECTION OF GYPSUM BOARD ON REAR HORIZONTAL WALL.
000000	9 CLEAN ELEVATOR PIT AND REMOVE ACCUMULATED TRASH.
000000	10 SMOKE DETECTORS, STROBE LIGHTS, FIRE SPRINKLER HEADS, AND ANY OTHER DEVICES SHALL REMAIN IN SERVICE DURING CONSTRUCTION.

FLOOR PLAN GENERAL NOTES	
1 -	SEE SHEET A02 FOR PROJECT GENERAL NOTES
2 -	COORDINATE WITH ELECTRICAL DRAWINGS FOR ALL LIGHTING, POWER, AND DATA REQUIREMENTS.
3 -	ALL INT. WALLS ARE ASSUMED TO BE 2x6 METAL STUD WALLS UNLESS SHOWN OTHERWISE.



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PROJECT TITLE:  
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**2540 WASHINGTON BOULEVARD ODGEN, UTAH 84401**

MARK	DATE	DESCRIPTION
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ISSUE TYPE: CONSTRUCTION SET


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SHEET TITLE  
**FLOOR PLANS**

SHEET NUMBER  
**A-103**

SHEET 05 OF 18




**BASEMENT FLOOR REFLECTED CEILING PLAN**

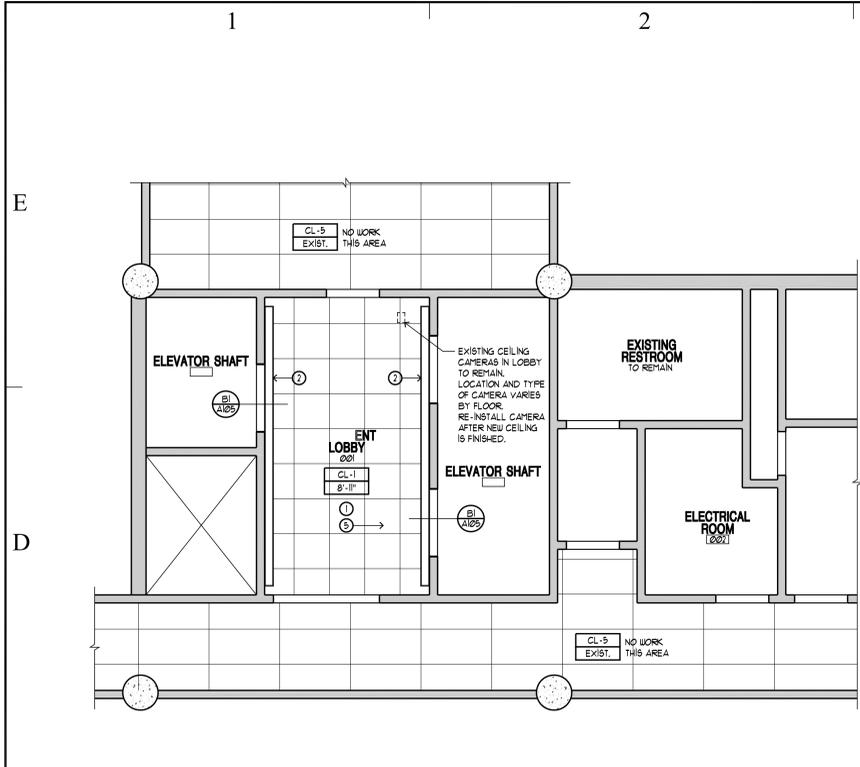SCALE: 1/4" = 1'-0"

C2  
A-104




NOTE:  
SEE SHEET 0204 FOR FINISH SCHEDULE

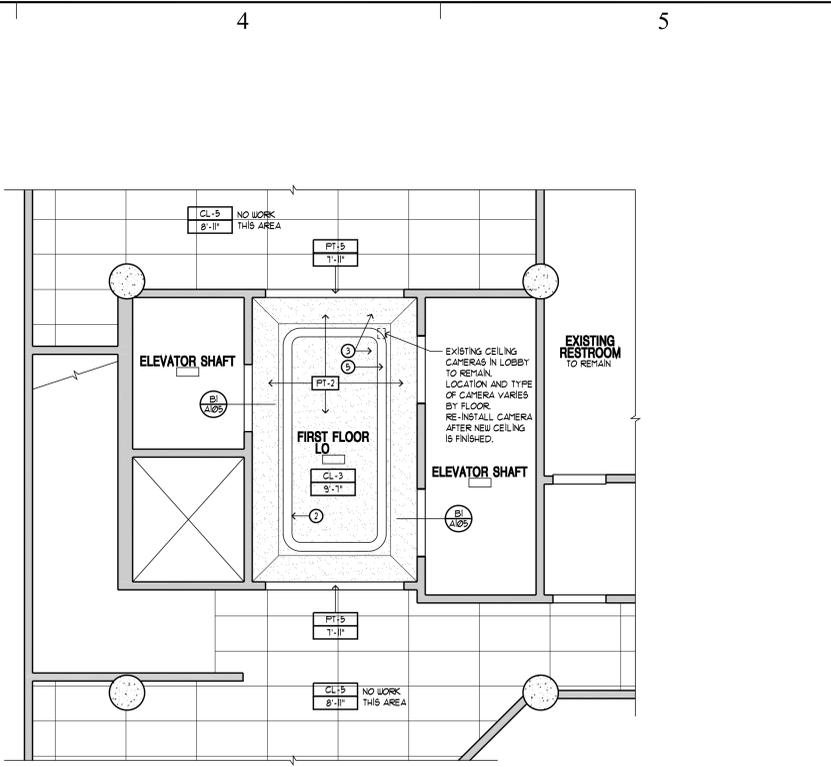

**FIRST FLOOR REFLECTED CEILING PLAN**

SCALE: 1/4" = 1'-0"


C5  
A-102

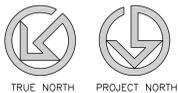

**SECOND FLOOR REFLECTED CEILING PLAN**

SCALE: 1/4" = 1'-0"


A2  
A-102

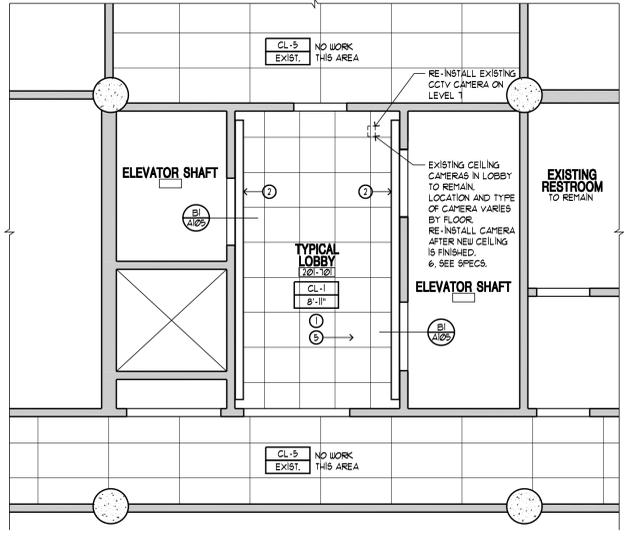

**TYPICAL FLOOR REFLECTED CEILING PLAN  
LEVEL 3 THRU 7**

SCALE: 1/4" = 1'-0"

A4  
A-102

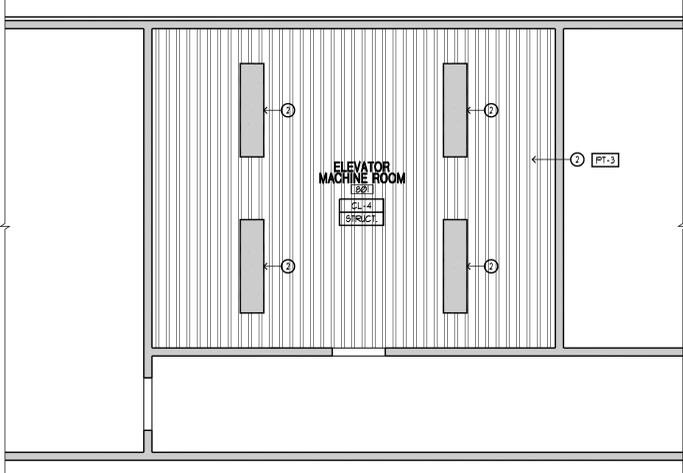

**PENTHOUSE REFLECTED CEILING PLAN**

SCALE: 1/4" = 1'-0"

A6  
A-102



NOTE:  
CONTRACTOR SHALL VERIFY ALL LOCATIONS  
AND DIMENSIONS OF CONTROL RACKS,  
HOSTILITY MACHINES AND VENT DUCTS.

REFLECTED CEILING PLAN LEGEND		
PATTERN/SYMBOL	SECTION	DESCRIPTION
[Pattern]	000000	NEW SUSPENDED ACOUSTIC PANEL LAY-IN TILE CEILING SYSTEM.
[Pattern]	000000	EXISTING GYPSUM BOARD CEILING TO REMAIN, RE-PAINT, SEE FINISH SCHEDULE ON SHEET 0204.
[Pattern]	000000	RE-PAINT EXISTING EXPOSED CEILING, SEE FINISH SCHEDULE ON SHEET 0204.
[Pattern]	000000	EXISTING ACOUSTIC LAY-IN TILE CEILING TO REMAIN IN OFFICE AREAS.

REFLECTED CEILING PLAN KEY NOTES	
SECTION	DESCRIPTION
000000 1	REMOVE EXISTING SUSPENDED CEILING SYSTEM. REPLACE WITH NEW SUSPENDED CEILING SYSTEM.
000000 2	EXISTING LIGHT FIXTURE TO REMAIN. SEE ELECTRICAL DUGS.
000000 3	RE-PAINT EXISTING GYPSUM BOARD CEILING, SEE FINISH SCHEDULE ON SHEET 0204.
000000 4	NOT USED.
000000 5	SMOKE DETECTORS, STROBE LIGHTS, FIRE SPRINKLER HEADS, AND ANY OTHER DEVICES SHALL REMAIN IN SERVICE DURING CONSTRUCTION.

REFLECTED CEILING PLAN GENERAL NOTES	
1 -	SEE SHEET A02 FOR PROJECT GENERAL NOTES. REVIEW ALL NOTES PRIOR TO CONSTRUCTION.
2 -	ALL CEILING HEIGHTS ARE MEASURED FROM TOP OF SLAB TO BOTTOM OF CEILING FINISH, UNO.
3 -	COORDINATE WITH ELECTRICAL DRAWINGS FOR ALL LIGHTING, POWER, AND DATA REQUIREMENTS.



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planners  
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6465 South 3000 East  
Suite 205  
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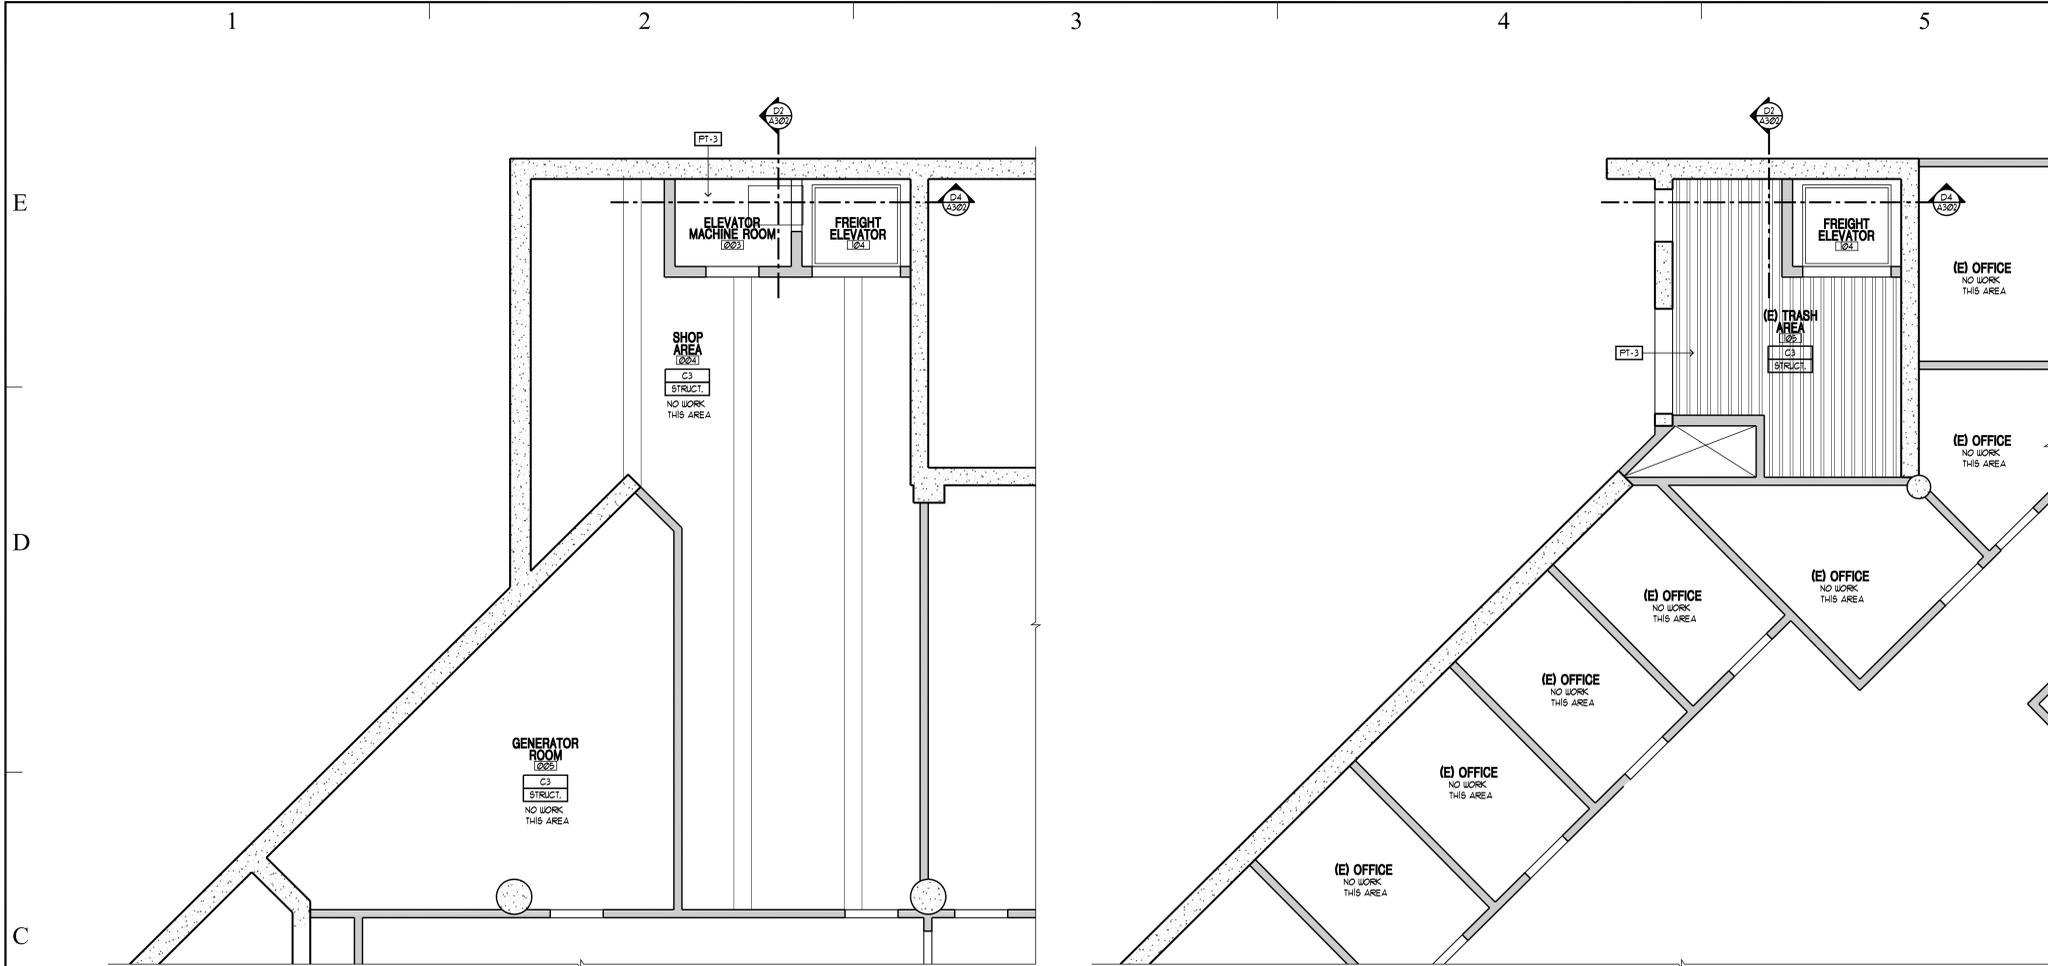
SHEET TITLE

**CEILING PLANS**

SHEET NUMBER

**A-104**

SHEET 06 OF 18







REFLECTED CEILING PLAN LEGEND	
PATTERN/SYMBOL	DESCRIPTION
[Pattern]	NEW SUSPENDED ACOUSTIC PANEL LAY-IN TILE CEILING SYSTEM
[Pattern]	EXISTING GYPSUM BOARD CEILING TO REMAIN, RE-PAINT, SEE FINISH SCHEDULE ON SHEET 1204.
[Pattern]	RE-PAINT EXISTING EXPOSED CEILING, SEE FINISH SCHEDULE ON SHEET 1204.
[Pattern]	EXISTING ACOUSTIC LAY-IN TILE CEILING TO REMAIN IN OFFICE AREAS.

REFLECTED CEILING PLAN KEY NOTES	
SECTION	DESCRIPTION
000000	NOT USED

REFLECTED CEILING PLAN GENERAL NOTES	
1 -	SEE SHEET A02 FOR PROJECT GENERAL NOTES, REVIEW ALL NOTES PRIOR TO CONSTRUCTION.
2 -	ALL CEILING HEIGHTS ARE MEASURED FROM TOP OF SLAB TO BOTTOM OF CEILING FINISH, UNO.
3 -	COORDINATE WITH ELECTRICAL DRAWINGS FOR ALL LIGHTING, POWER, AND DATA REQUIREMENTS.



**SUSPENDED CEILING DETAIL**  
SCALE: 1/8" = 1'-0"  
DT-CG-01 B1 A105

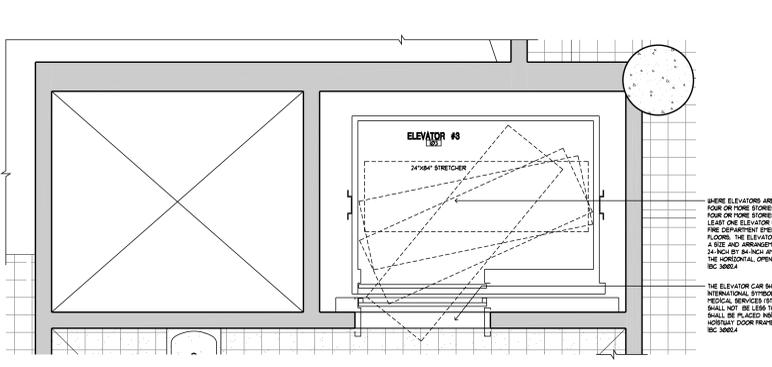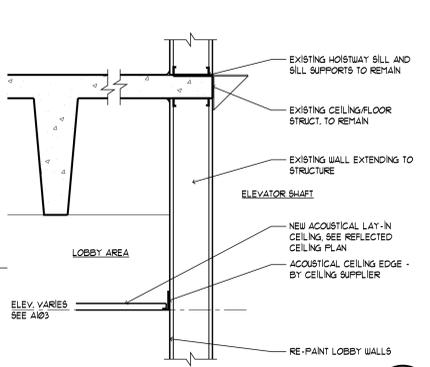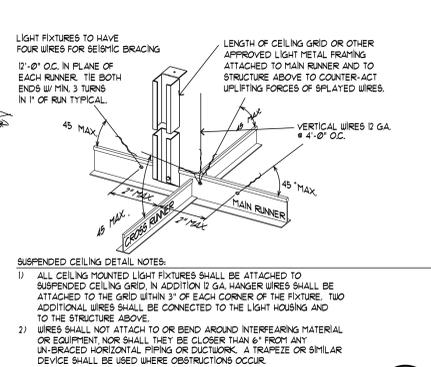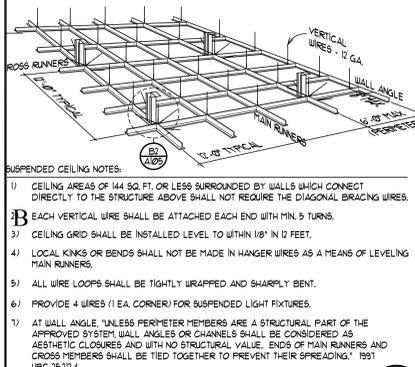**SUSPENDED CEILING DETAIL**  
SCALE: 1/8" = 1'-0"  
DT-CG-02 B2 A105

**CEILING DETAIL**  
SCALE: 1" = 1'-0"  
DT-CG-03 B3 A105

**ELEVATOR #3 STRETCHER DETAIL**  
SCALE: 1/2" = 1'-0"  
DT-CG-04 B5 A105



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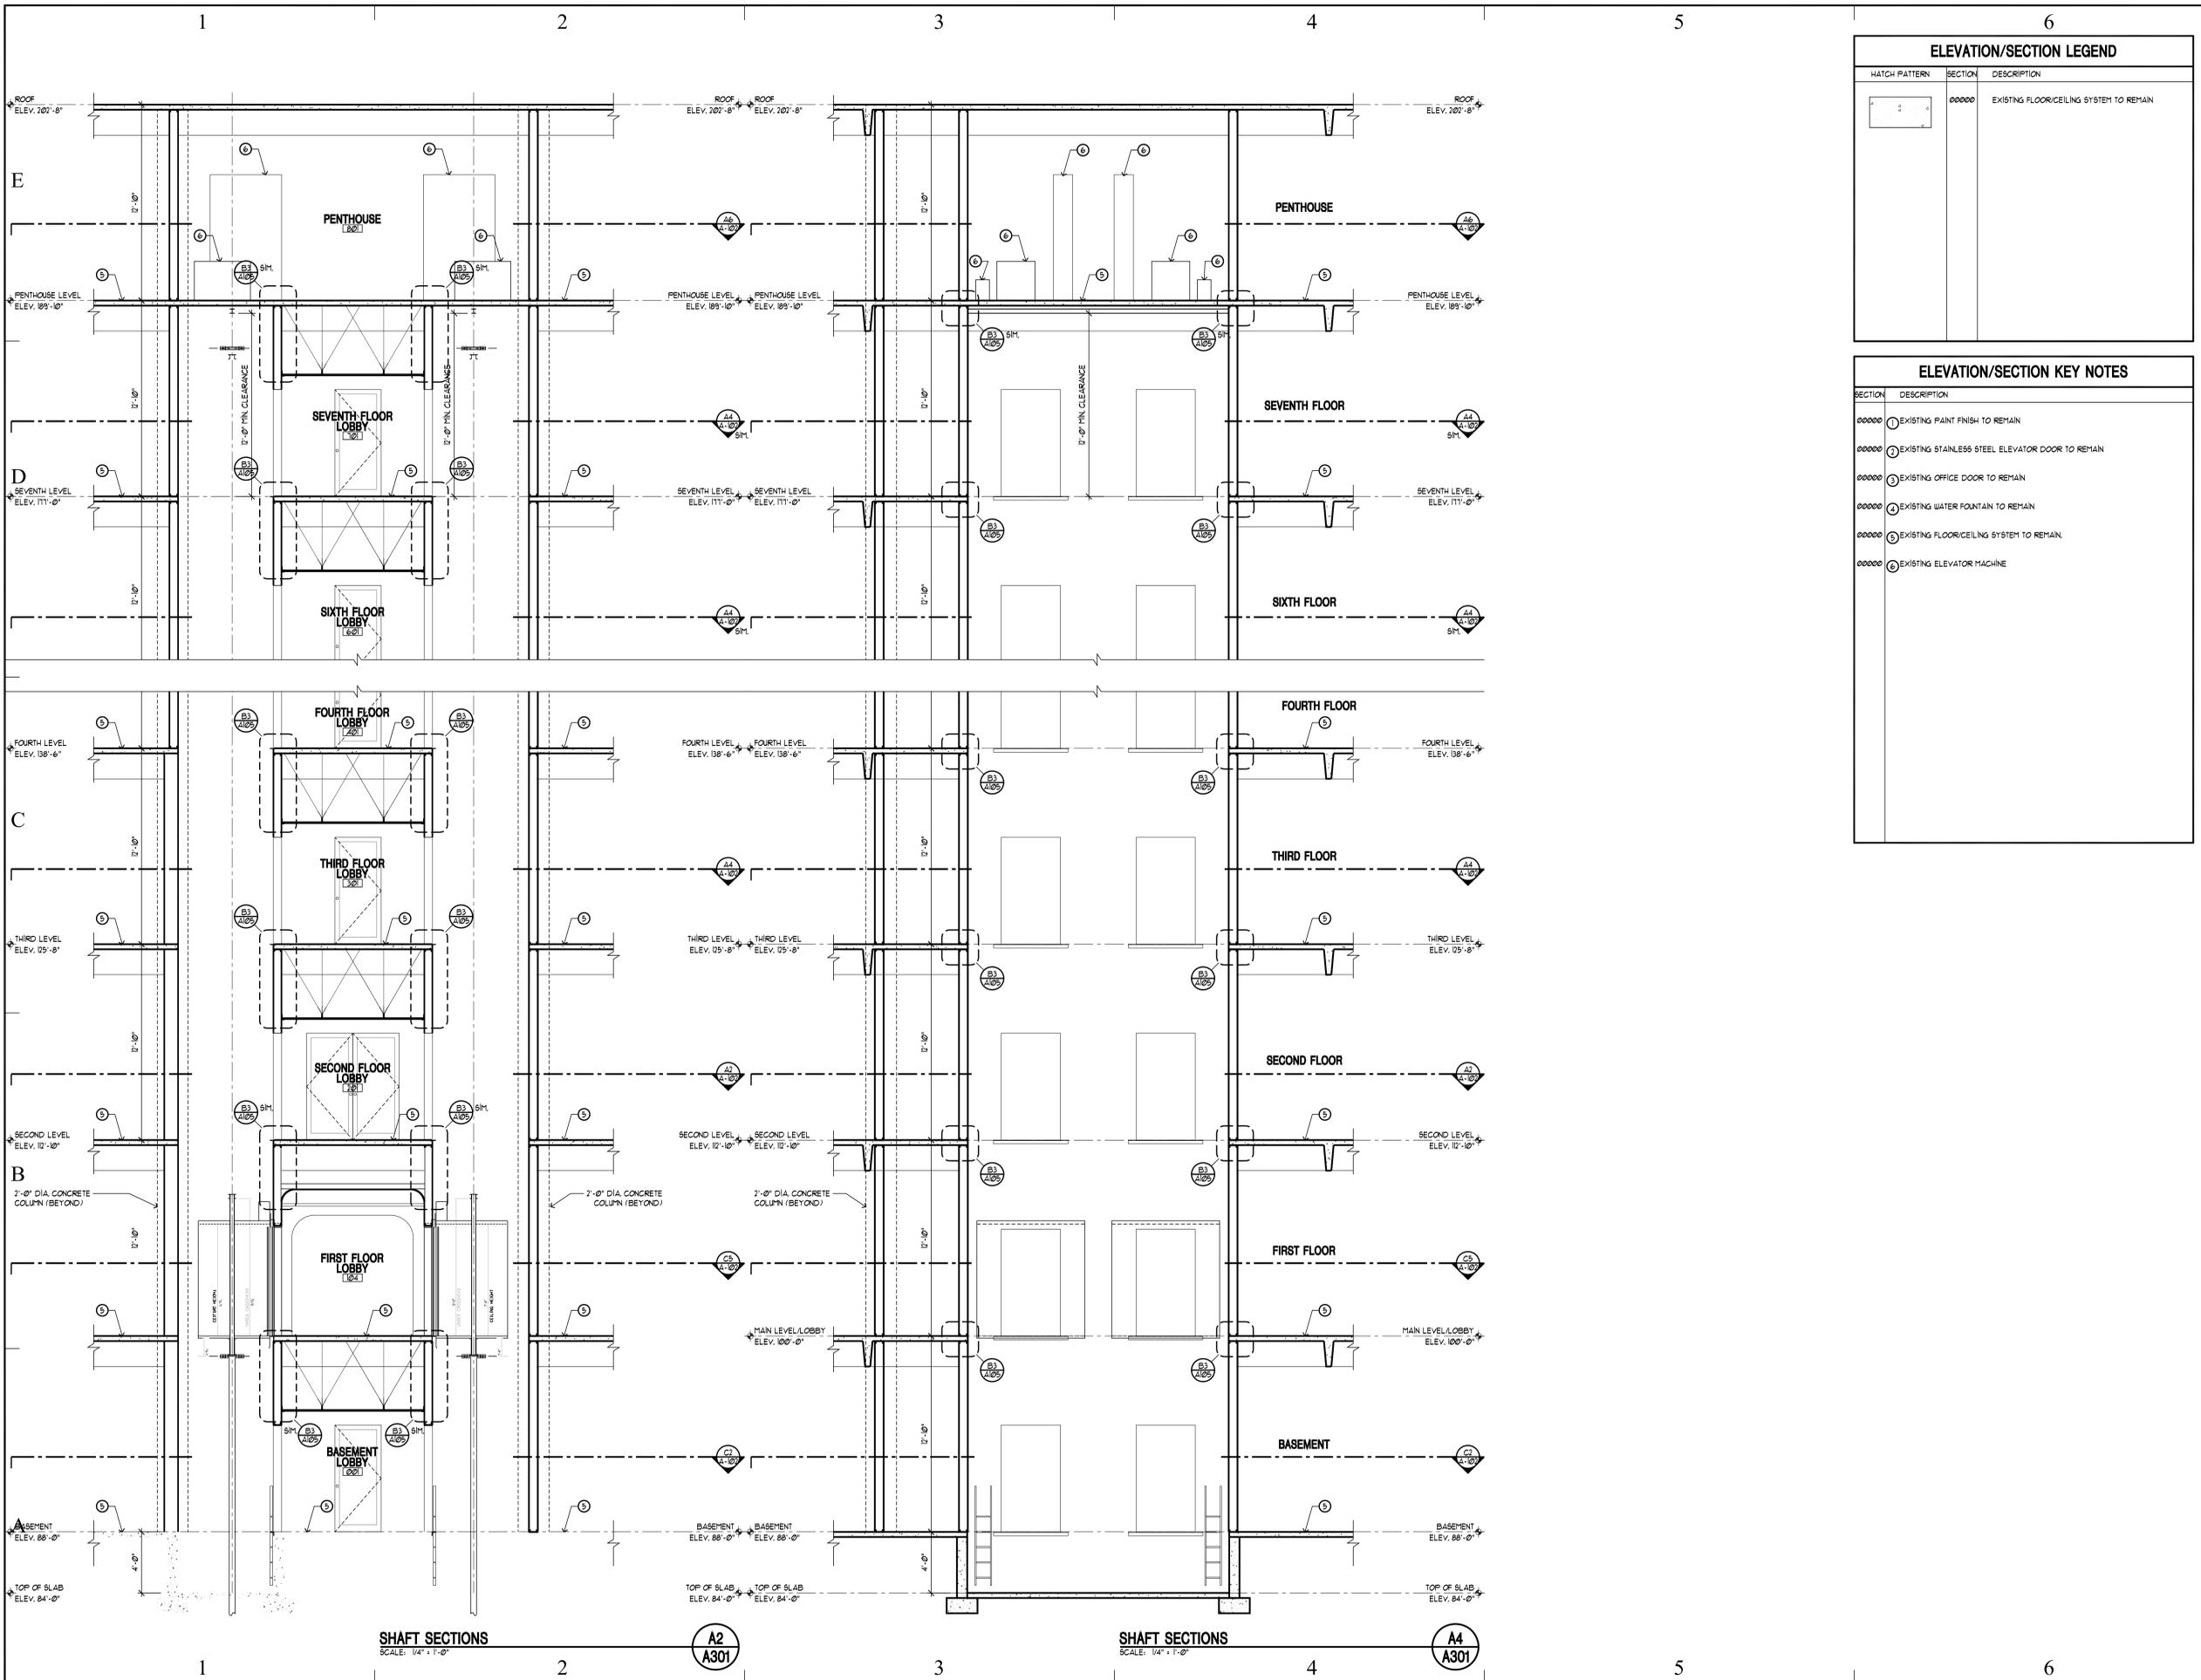
SHEET TITLE

**CEILING PLANS**

SHEET NUMBER

**A-105**

SHEET 07 OF 18



ELEVATION/SECTION LEGEND		
HATCH PATTERN	SECTION	DESCRIPTION
[Hatch Pattern]	000000	EXISTING FLOOR/CEILING SYSTEM TO REMAIN

ELEVATION/SECTION KEY NOTES	
SECTION	DESCRIPTION
000000	① EXISTING PAINT FINISH TO REMAIN
000000	② EXISTING STAINLESS STEEL ELEVATOR DOOR TO REMAIN
000000	③ EXISTING OFFICE DOOR TO REMAIN
000000	④ EXISTING WATER FOUNTAIN TO REMAIN
000000	⑤ EXISTING FLOOR/CEILING SYSTEM TO REMAIN
000000	⑥ EXISTING ELEVATOR MACHINE

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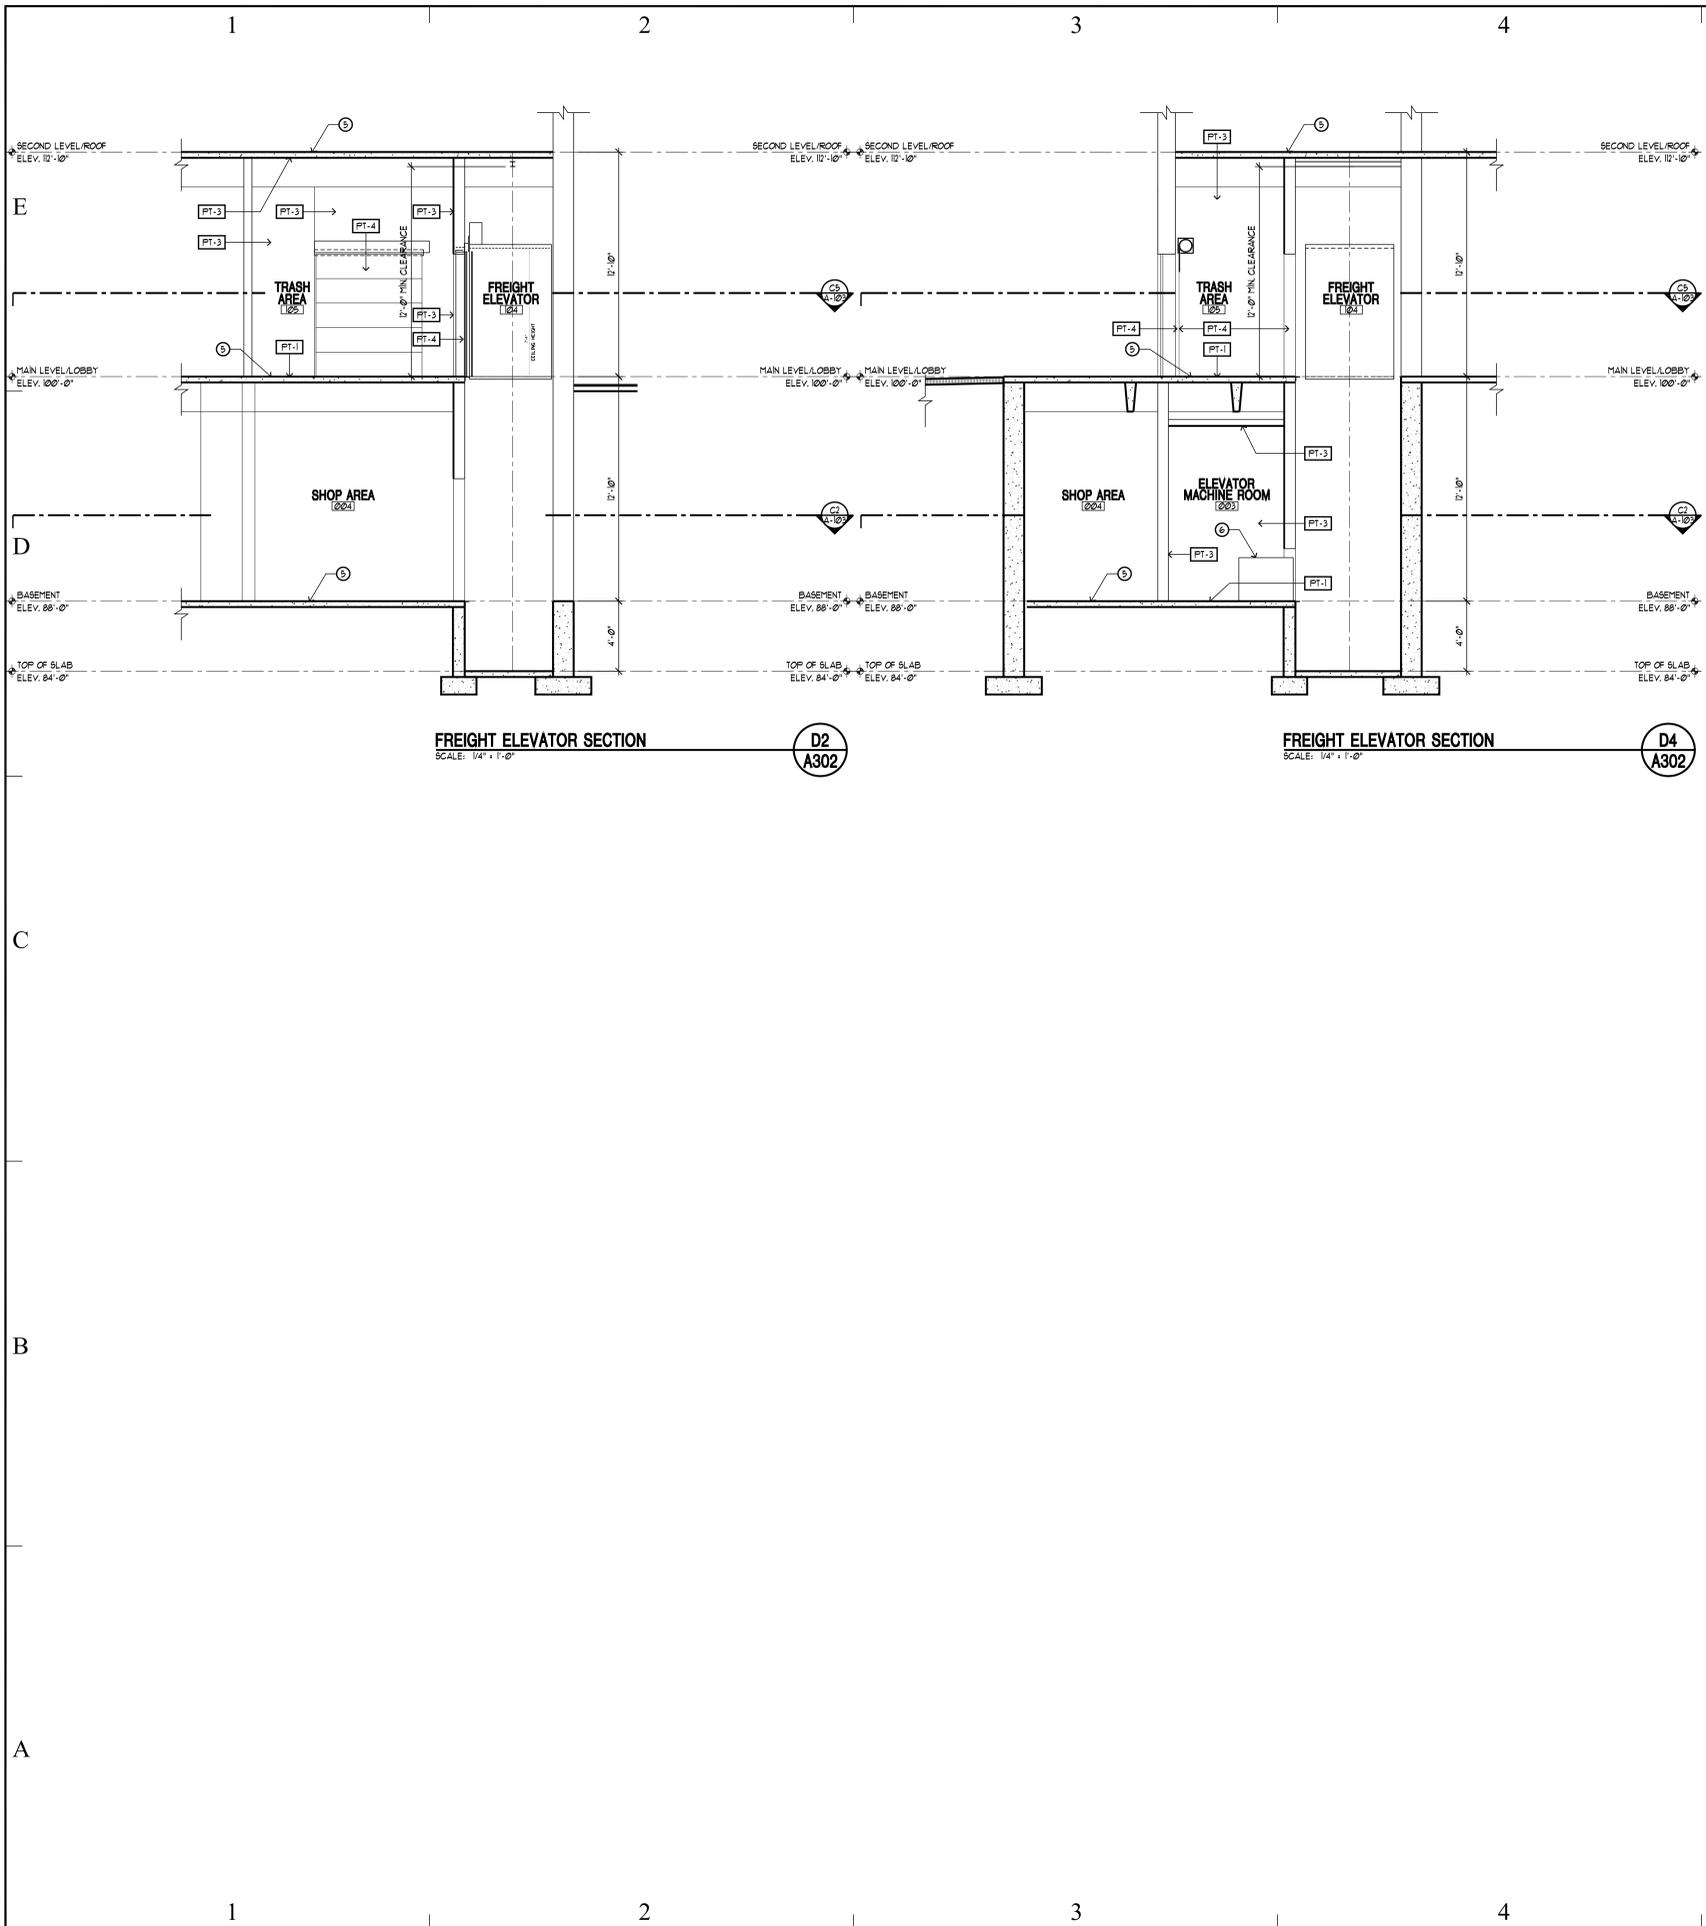
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SHEET TITLE  
**BUILDING SECTIONS**

SHEET NUMBER  
**A-301**

SHEET 08 OF 18



ELEVATION/SECTION LEGEND		
HATCH PATTERN	SECTION	DESCRIPTION
[Hatch Pattern]	000000	EXISTING FLOOR/CEILING SYSTEM TO REMAIN

ELEVATION/SECTION KEY NOTES	
SECTION	DESCRIPTION
000000	① EXISTING PAINT FINISH TO REMAIN
000000	② EXISTING STAINLESS STEEL ELEVATOR DOOR TO REMAIN
000000	③ EXISTING OFFICE DOOR TO REMAIN
000000	④ EXISTING WATER FOUNTAIN TO REMAIN
000000	⑤ EXISTING FLOOR/CEILING SYSTEM TO REMAIN
000000	⑥ EXISTING ELEVATOR MACHINE



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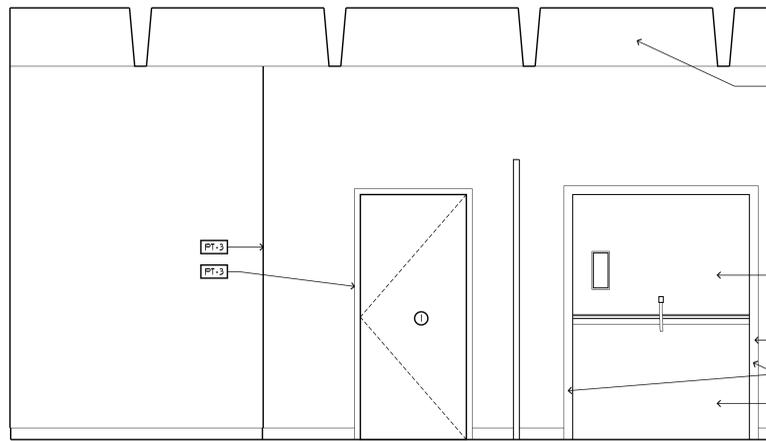
SHEET TITLE

**BUILDING SECTIONS**

SHEET NUMBER


**A-302**

SHEET 09 OF 18



**BASEMENT FREIGHT ELEVATOR ELEVATION**  
SCALE: 1/2" = 1'-0"  
**D3**  
**I201**

NOTE: SEE SHEET I204 FOR FINISH SCHEDULE

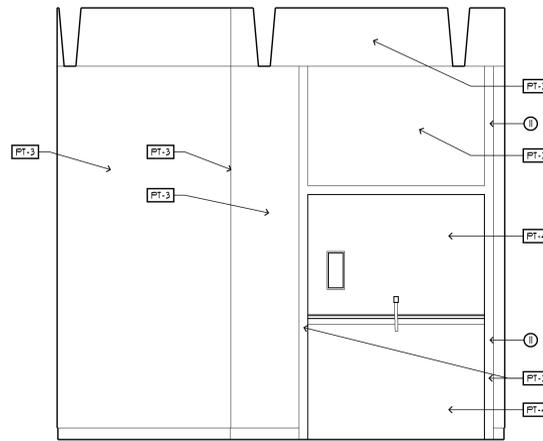

**FIRST FLOOR FREIGHT ELEVATOR ELEVATION**  
SCALE: 1/2" = 1'-0"  
**D5**  
**I201**

ELEVATION/SECTION LEGEND		
HATCH PATTERN	SECTION	DESCRIPTION
	000000	EXISTING FLOOR/CEILING SYSTEM TO REMAIN

ELEVATION/SECTION KEY NOTES	
SECTION	DESCRIPTION
000000	① EXISTING PAINT FINISH TO REMAIN
000000	② NOT USED
000000	③ NOT USED
000000	④ NOT USED
000000	⑤ NOT USED
000000	⑥ NOT USED
000000	⑦ NOT USED
000000	⑧ NOT USED
000000	⑨ NOT USED
000000	⑩ PAINT EXISTING HOLLOW METAL DOOR FRAME



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**INTERIOR ELEVATIONS**

SHEET NUMBER

**I- 201**


SHEET 10 OF 18




**TRASH AREA #105 & FREIGHT ELEVATOR**  
SCALE: N.T.S. 1'-0"  
**C2**  
**I201**




**DOCK #106 & TRASH AREA #105**  
SCALE: N.T.S. 1'-0"  
**C3**  
**I201**

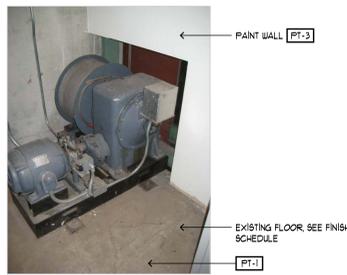


**FREIGHT ELEV. MACHINE ROOM #003**  
SCALE: N.T.S. 1'-0"  
**C4**  
**I201**

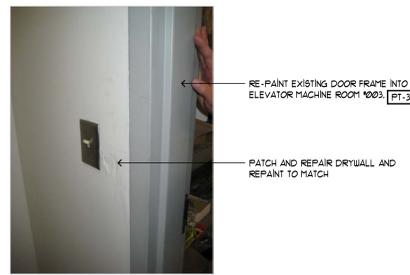


**FREIGHT ELEV. MACHINE ROOM #003**  
SCALE: N.T.S. 1'-0"  
**C5**  
**I201**

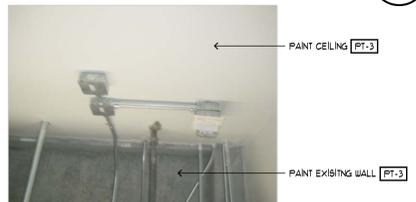


**FREIGHT ELEV. ROOM #003**  
SCALE: N.T.S. 1'-0"  
**B2**  
**I201**

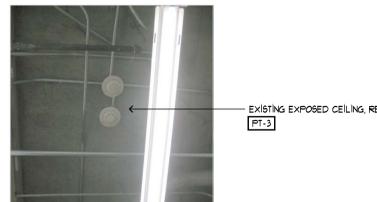


**BASEMENT SHOP CEILING #004**  
SCALE: N.T.S. 1'-0"  
**B3**  
**I201**

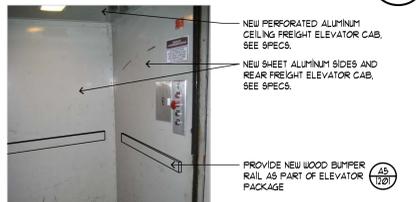

**FREIGHT ELEVATOR #104**  
SCALE: N.T.S. 1'-0"  
**B4**  
**I201**

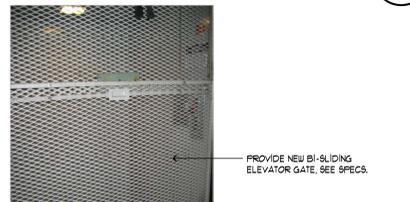

**FREIGHT ELEVATOR #104**  
SCALE: N.T.S. 1'-0"  
**B5**  
**I201**

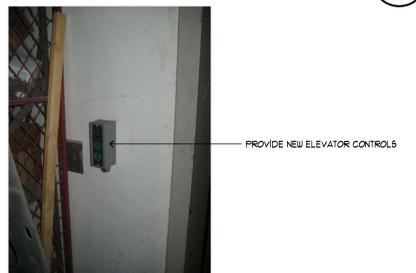

**FREIGHT ELEVATOR #104**  
SCALE: N.T.S. 1'-0"  
**A2**  
**I201**



**FREIGHT ELEVATOR #104**  
SCALE: N.T.S. 1'-0"  
**A3**  
**I201**



**NEW FREIGHT ELEVATOR BUMPER DETAIL**  
SCALE: 6" = 1'-0"  
DA-EL-006  
**A5**  
**I201**

1

2

3

4

5

6

E

D

C

B

A

1


2

3

4

5

6

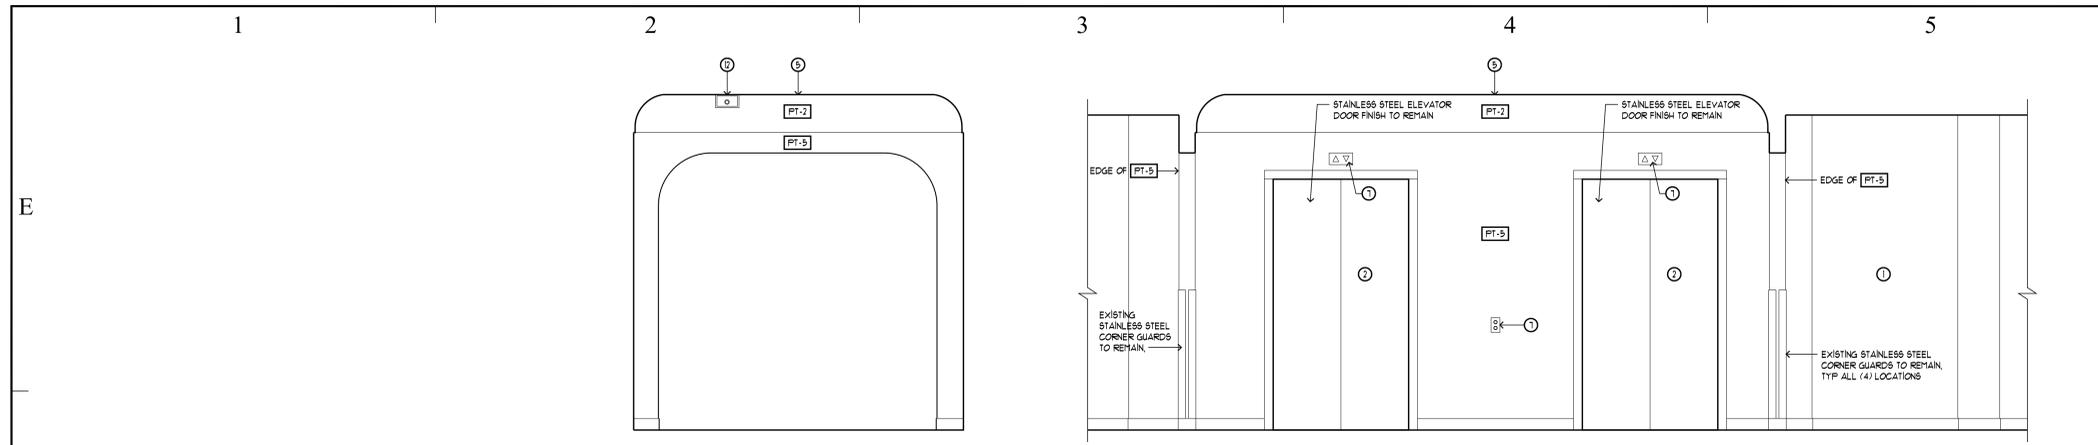

**MAIN FLOOR LOBBY ELEVATIONS**

SCALE: 1/2" = 1'-0"


**D3**  
I-201

**MAIN FLOOR LOBBY ELEVATIONS**

SCALE: 1/2" = 1'-0"

**D4**  
A201

NOTE:  
SEE SHEET I204 FOR FINISH SCHEDULE

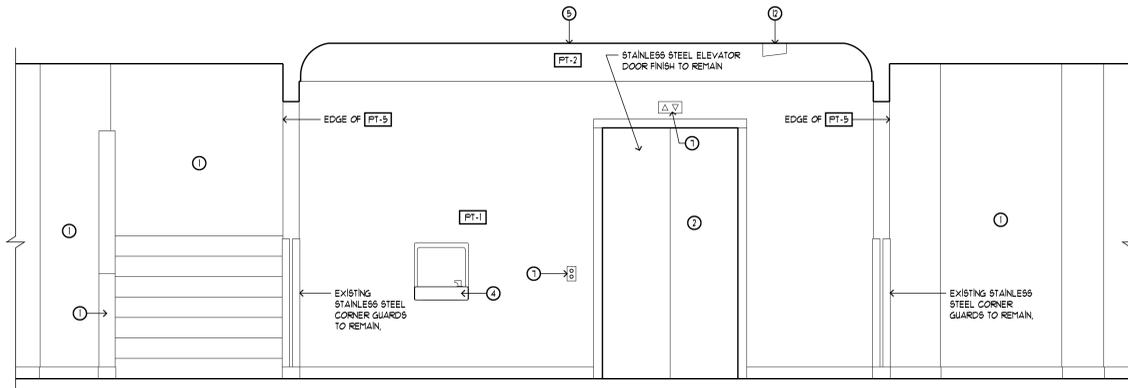

**MAIN FLOOR LOBBY ELEVATIONS**

SCALE: 1/2" = 1'-0"

**C4**  
I201



**LOBBY #104**

SCALE: 1/8" = 1'-0"

**B2**  
I202

**LOBBY #104**

SCALE: 1/8" = 1'-0"

**B3**  
I202

**LOBBY #104**

SCALE: 1/8" = 1'-0"

**B4**  
I202

**LOBBY #104**

SCALE: 1/8" = 1'-0"

**B5**  
I202

ELEVATION/SECTION LEGEND		
HATCH PATTERN	SECTION	DESCRIPTION
	000000	EXISTING FLOOR/CEILING SYSTEM TO REMAIN

ELEVATION/SECTION KEY NOTES	
SECTION	DESCRIPTION
000000	1) EXISTING PAINT FINISH TO REMAIN - NO WORK THIS AREA.
000000	2) EXISTING STAINLESS STEEL ELEVATOR DOORS AND FRAMES TO REMAIN. PROTECT DURING CONSTRUCTION.
000000	3) NOT USED
000000	4) EXISTING WATER FOUNTAIN TO REMAIN. PROTECT DURING CONSTRUCTION.
000000	5) EXISTING SUSPENDED CEILING SYSTEM TO REMAIN.
000000	6) NOT USED
000000	7) INSTALL NEW HALL LANTERNS AND CALL BUTTONS AND REPAIR WALL SURFACES AS REQUIRED.
000000	8) NOT USED
000000	9) NOT USED
000000	10) NOT USED
000000	11) NOT USED
000000	12) EXISTING CEILING CAMERAS IN LOBBY TO REMAIN. LOCATION AND TYPE OF CAMERA VARIES BY FLOOR. RE-INSTALL CAMERA AFTER NEW CEILING IS FINISHED.

**jsa architects**  
architects  
planners  
interior designers

6465 South 3000 East  
Suite 205  
Salt Lake City, UT 84121  
Ph: 801.733.2500  
Fax: 801.733.2501  
www.jsa-llc.com

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CONSULTANT:

BUILDING NAME:

**OGDEN REGIONAL CENTER**

PROJECT TITLE:

**OGDEN REGIONAL CENTER ELEVATOR MODERNIZATION**

**2540 WASHINGTON BOULEVARD  
OGDEN, UTAH 84401**

MARK	DATE	DESCRIPTION
	XX-XX-XX	XXX

ISSUE TYPE: CONSTRUCTION SET

ISSUE DATE: SEPTEMBER 14, 2009

DFCM PROJECT NO: 09071310  
CAD PROJECT NO: 09034  
CAD DWG FILE:  
DRAWN BY: JSA  
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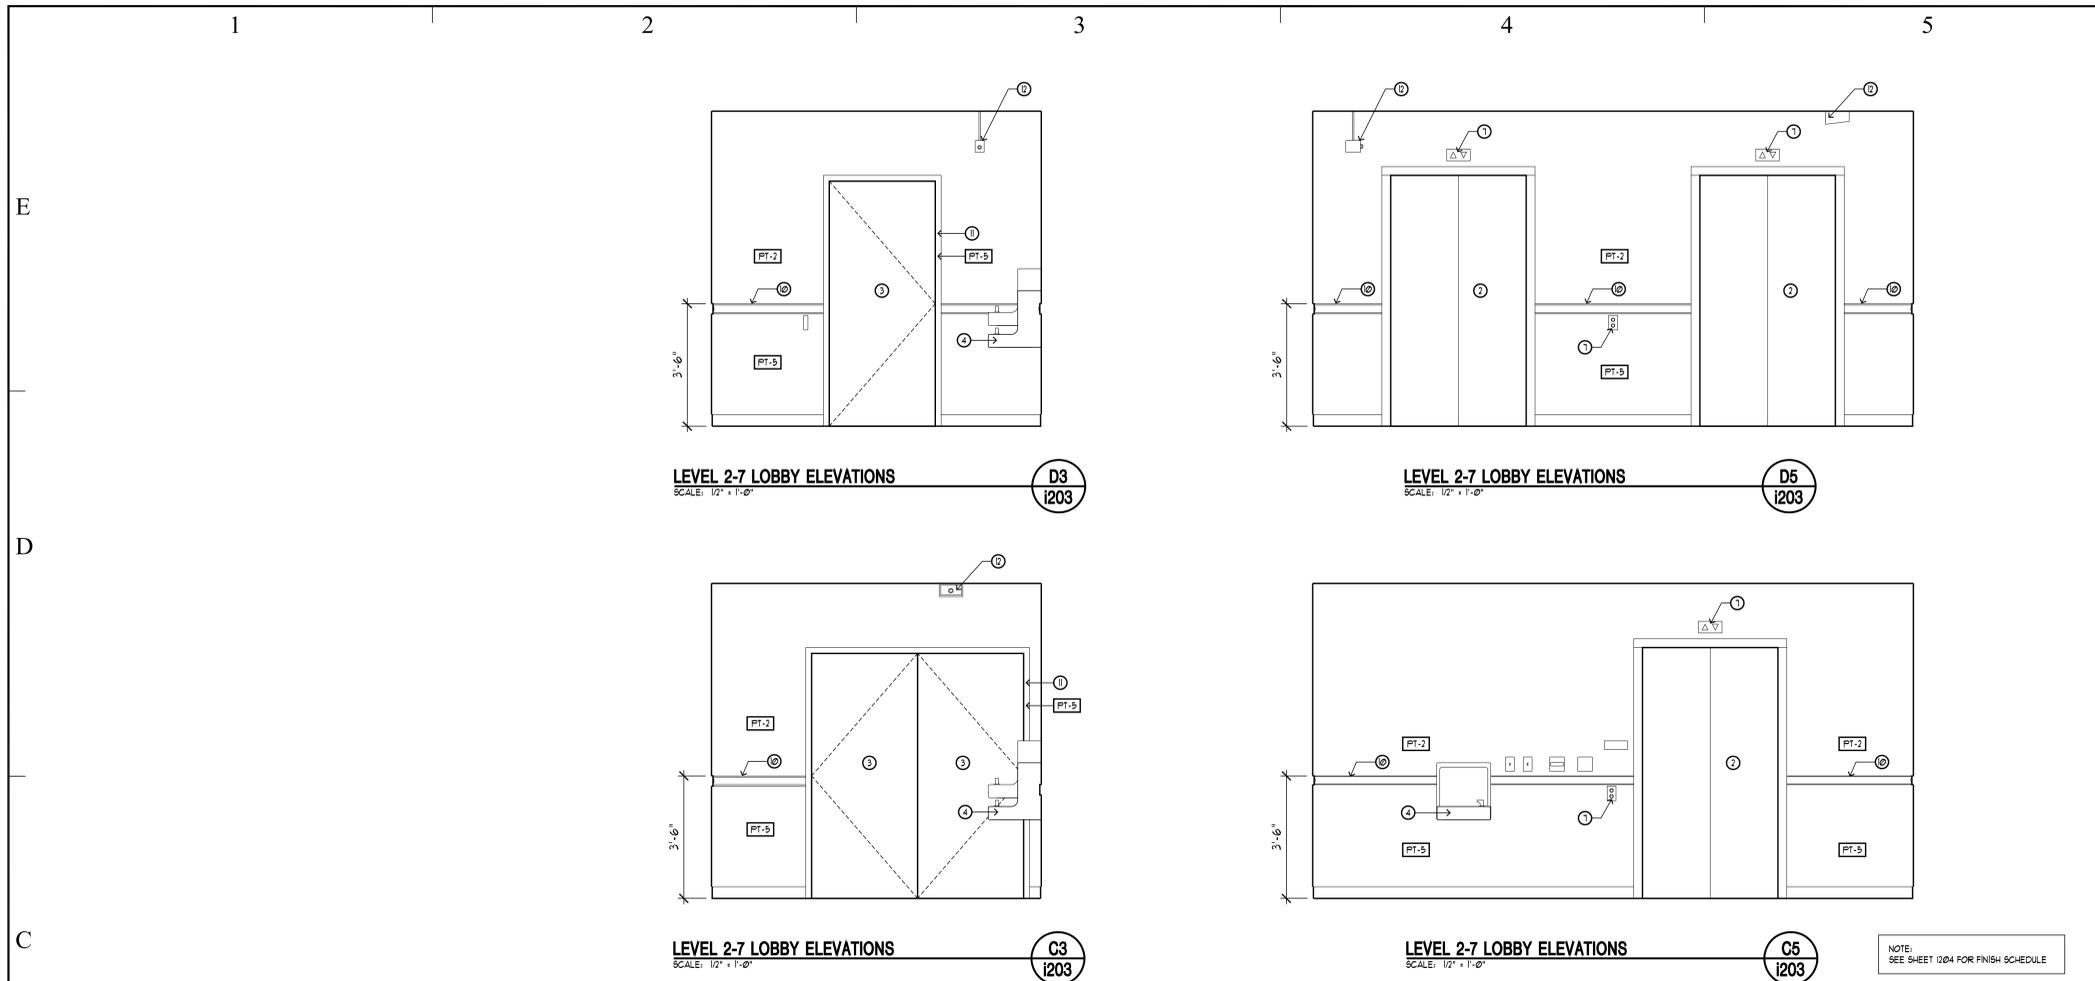
SHEET TITLE

**INTERIOR ELEVATIONS**

SHEET NUMBER

**I- 202**

SHEET 11 OF 18



ELEVATION/SECTION LEGEND		
HATCH PATTERN	SECTION	DESCRIPTION
	000000	EXISTING FLOOR/CEILING SYSTEM TO REMAIN

ELEVATION/SECTION KEY NOTES	
SECTION	DESCRIPTION
000000 ①	NOT USED
000000 ②	EXISTING STAINLESS STEEL ELEVATOR DOORS AND FRAMES TO REMAIN. PROTECT DURING CONSTRUCTION.
000000 ③	EXISTING OFFICE DOOR TO REMAIN
000000 ④	EXISTING WATER FOUNTAIN TO REMAIN. PROTECT DURING CONSTRUCTION.
000000 ⑤	NOT USED
000000 ⑥	NOT USED
000000 ⑦	INSTALL NEW HALL LANTERNS AND CALL BUTTONS AND REPAIR WALL SURFACES AS REQUIRED.
000000 ⑧	NOT USED
000000 ⑨	NOT USED
000000 ⑩	NEW SURFACE APPLIED RAIL, SEE SPECS.
000000 ⑪	PAINT EXISTING HOLLOW METAL DOOR FRAME.
000000 ⑫	EXISTING CEILING CAMERAS IN LOBBY TO REMAIN. LOCATION AND TYPE OF CAMERA VARIES BY FLOOR. RE-INSTALL CAMERA AFTER NEW CEILING IS FINISHED.

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MARK	DATE	DESCRIPTION
	XX-XX-XX	XXX

ISSUE TYPE: CONSTRUCTION SET


ISSUE DATE: SEPTEMBER 14, 2009

DFCM PROJECT NO: 09071310  
 CAD PROJECT NO: 09034  
 CAD DWG FILE:  
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SHEET TITLE  
**INTERIOR ELEVATIONS**

SHEET NUMBER  
**I- 203**

SHEET 12 OF 18

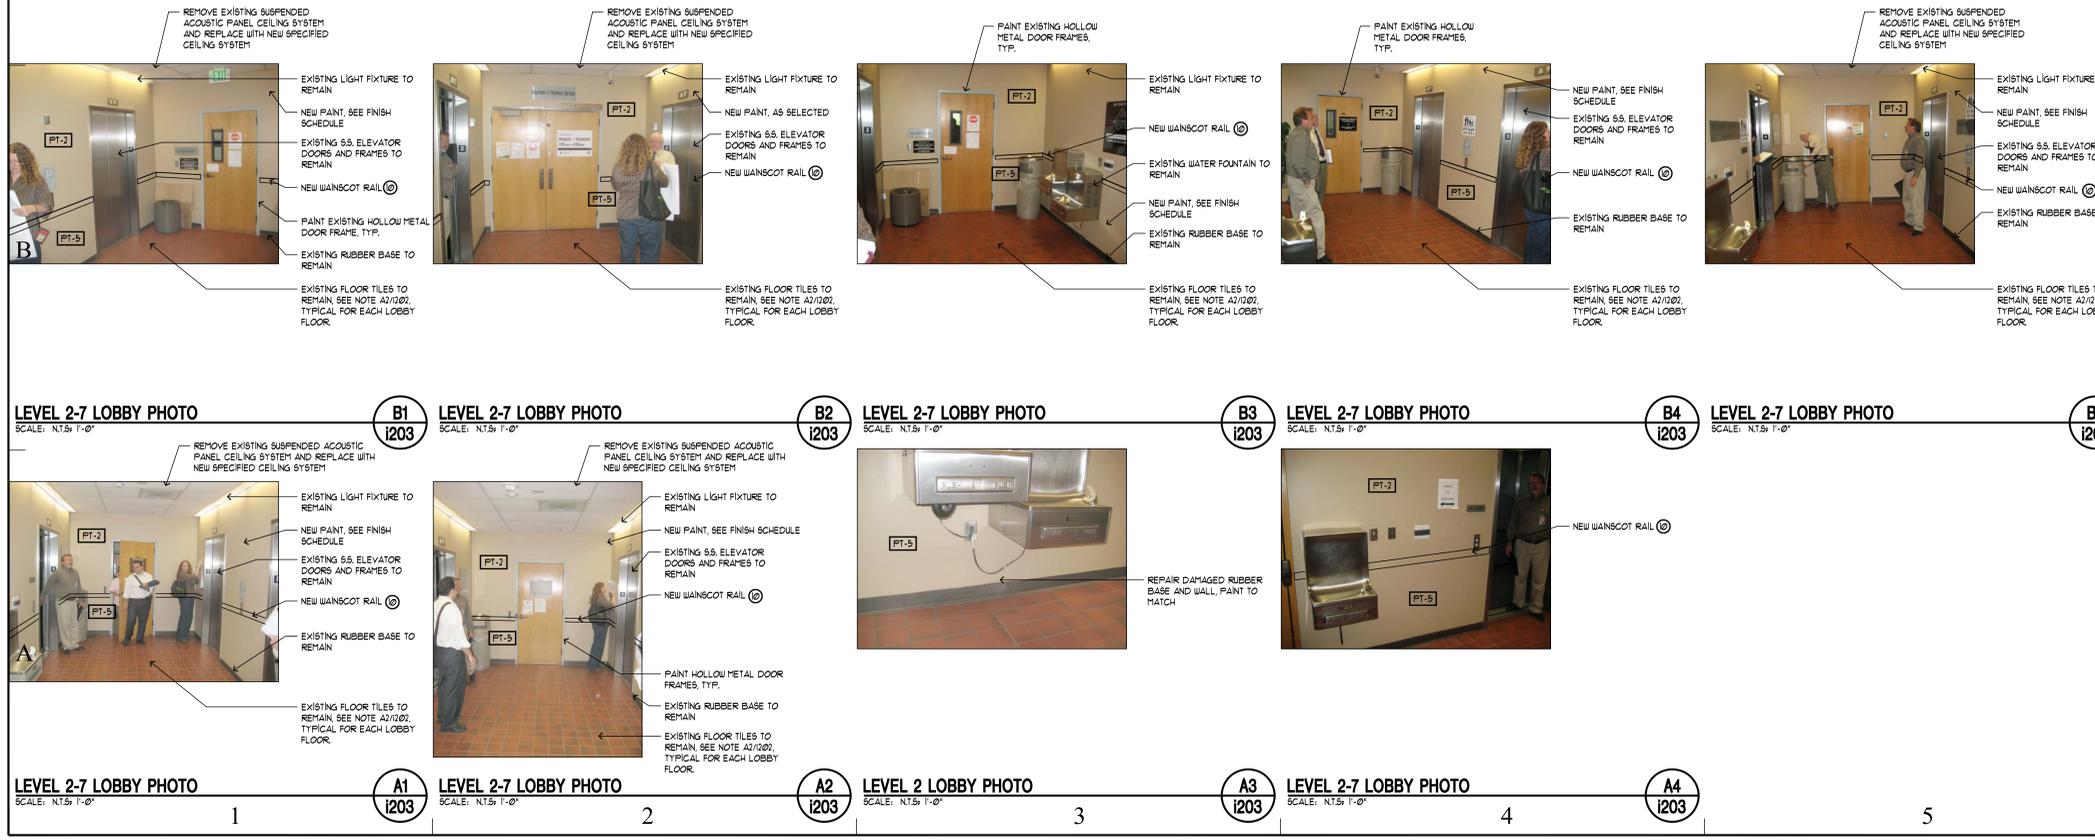

**LEVEL 2-7 LOBBY PHOTO** SCALE: N.T.S. 1'-0" **B1 I203**

**LEVEL 2-7 LOBBY PHOTO** SCALE: N.T.S. 1'-0" **B2 I203**

**LEVEL 2-7 LOBBY PHOTO** SCALE: N.T.S. 1'-0" **B3 I203**

**LEVEL 2-7 LOBBY PHOTO** SCALE: N.T.S. 1'-0" **B4 I203**


**LEVEL 2-7 LOBBY PHOTO** SCALE: N.T.S. 1'-0" **B5 I203**

**LEVEL 2-7 LOBBY PHOTO** SCALE: N.T.S. 1'-0" **A1 I203**

**LEVEL 2-7 LOBBY PHOTO** SCALE: N.T.S. 1'-0" **A2 I203**

**LEVEL 2 LOBBY PHOTO** SCALE: N.T.S. 1'-0" **A3 I203**

**LEVEL 2-7 LOBBY PHOTO** SCALE: N.T.S. 1'-0" **A4 I203**

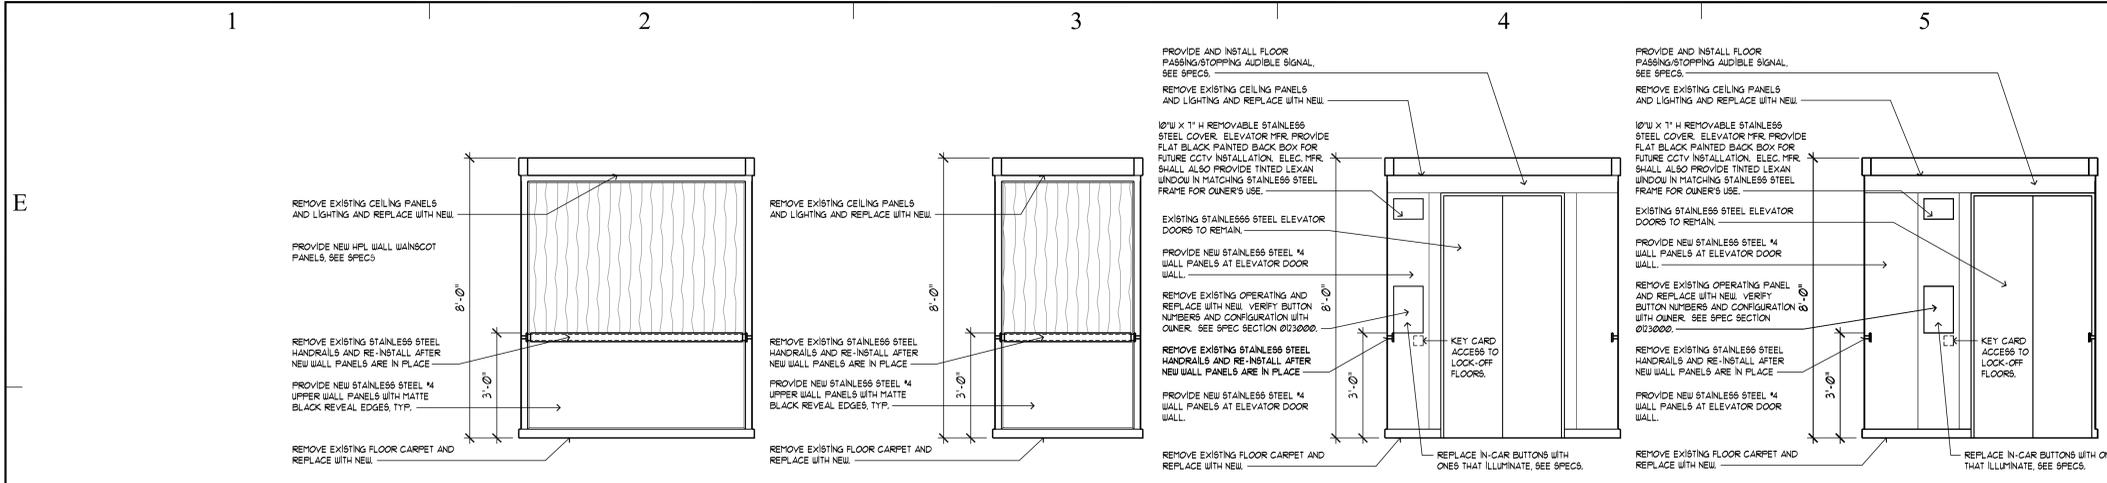

**ELEVATOR #1-3**  
SCALE: 1/2" = 1'-0"


**ELEVATOR #1-2**  
SCALE: 1/2" = 1'-0"

**ELEVATOR #1-2**  
SCALE: 1/2" = 1'-0"


**ELEVATOR #3**  
SCALE: 1/2" = 1'-0"

**ELEVATOR #3**  
SCALE: 1/2" = 1'-0"

**NOTES:**  
1. SEE SHEET 1004 FOR FINISH SCHEDULE  
2. PROVIDE ALL PASSENGER CAR WALLS WITH PROTECTIVE BLANKETS INCLUDING OPERATING PANEL PROTECTION AND WITH BLANKET HANGER STUDS AS REQUIRED.

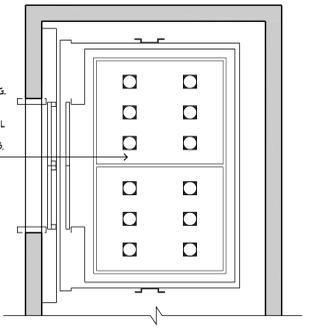


**ELEVATOR #1-2 CEILING PLAN**  
SCALE: 1/4" = 1'-0"

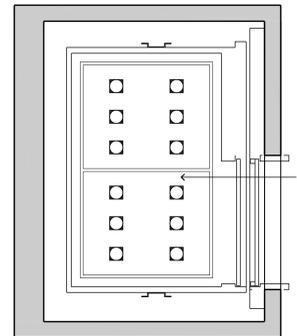

**ELEVATOR #3 CEILING PLAN**  
SCALE: 1/4" = 1'-0"



**ELEVATOR CAR**  
SCALE: N.T.S. 1'-0"

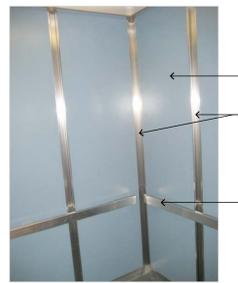

**ELEVATOR CAR**  
SCALE: N.T.S. 1'-0"

ELEVATION/SECTION LEGEND		
HATCH PATTERN	SECTION	DESCRIPTION
[Symbol]	00000	EXISTING FLOOR/CEILING SYSTEM TO REMAIN

ELEVATION/SECTION KEY NOTES	
DESCRIPTION	
01	NOT USED
02	NOT USED
03	NOT USED
04	NOT USED
05	NOT USED
06	NOT USED
07	NOT USED
08	NOT USED
09	NOT USED
10	NOT USED
11	NOT USED
12	NOT USED
13	NOT USED
14	NOT USED
15	NOT USED
16	NOT USED
17	NOT USED
18	NOT USED
19	NOT USED
20	NOT USED

ROOM FINISH SCHEDULE												
ROOM #	ROOM NAME	HEIGHT AFF.	CEILING	TYPE	WALLS				FLOOR & BASE FINISH		COUNTER TOP	REMARKS
					NORTH	EAST	SOUTH	WEST	FLOOR	BASE		
001	BASEMENT LOBBY	9'-0"	CL-1	PT-2/PT-5	PT-2/PT-5	PT-2/PT-5	PT-2/PT-5	TR-1	PT-1	N/A	-	-
002	ELECTRICAL ROOM	15'-0"	CL-5	NONE	NONE	NONE	NONE	NONE	FL-2	N/A	-	NO WORK THIS ROOM
003	ELEV. MACHINE ROOM	15'-0"	CL-3	PT-3	PT-3	PT-3	PT-3	NONE	FL-2	N/A	-	-
004	SHOP AREA	15'-0"	CL-5	NONE	NONE	NONE	NONE	NONE	-	N/A	-	NO WORK THIS AREA
005	GENERATOR ROOM	15'-0"	CL-5	NONE	NONE	NONE	NONE	EXIST. TR-1 TO REMAIN	-	N/A	-	SEE ELEC. DWGS FOR WORK IN THIS ROOM
101	ELEVATOR #1	8'-0"	CL-2	D3/1204	D4/1204	D3/1204	D2/1204	SEE ELEV. 1204	FG-1	N/A	-	-
102	ELEVATOR #2	8'-0"	CL-2	D3/1204	D4/1204	D3/1204	D2/1204	SEE ELEV. 1204	FG-1	N/A	-	-
103	ELEVATOR #3	8'-0"	CL-2	D3/1204	D3/1204	D3/1204	D3/1204	SEE ELEV. 1204	FG-1	N/A	-	-
104	FREIGHT ELEVATOR	8'-0"	CL-6	PT-3	PT-3	PT-3	PT-3	NONE	FL-1	N/A	-	-
105	FIRST FLOOR LOBBY	9'-11"	CL-3	PT-3	PT-3	PT-3	PT-3	TR-1	PT-1	N/A	-	SEE INT. ELEV. FOR 2-COLOR WALLS & CLG.
106	TRASH AREA	1'-6"	NONE	NONE	PT-3	NONE	NONE	EXISTING/NONE/REMAIN	N/A	N/A	-	PAINT EXISTING ELEVATOR DOOR FRAME
201	SECOND FLOOR LOBBY	9'-0"	CL-1	PT-2/PT-5	PT-2/PT-5	PT-2/PT-5	PT-2/PT-5	TR-1	PT-1	N/A	-	SEE INT. ELEV. FOR 2-COLOR WALLS
301	THIRD FLOOR LOBBY	9'-0"	CL-1	PT-2/PT-5	PT-2/PT-5	PT-2/PT-5	PT-2/PT-5	TR-1	PT-1	N/A	-	SEE INT. ELEV. FOR 2-COLOR WALLS
401	FOURTH FLOOR LOBBY	9'-0"	CL-1	PT-2/PT-5	PT-2/PT-5	PT-2/PT-5	PT-2/PT-5	TR-1	PT-1	N/A	-	SEE INT. ELEV. FOR 2-COLOR WALLS
501	FIFTH FLOOR LOBBY	9'-0"	CL-1	PT-2/PT-5	PT-2/PT-5	PT-2/PT-5	PT-2/PT-5	TR-1	PT-1	N/A	-	SEE INT. ELEV. FOR 2-COLOR WALLS
601	SIXTH FLOOR LOBBY	9'-0"	CL-1	PT-2/PT-5	PT-2/PT-5	PT-2/PT-5	PT-2/PT-5	TR-1	PT-1	N/A	-	SEE INT. ELEV. FOR 2-COLOR WALLS
701	SEVENTH FLOOR LOBBY	9'-0"	CL-1	PT-2/PT-5	PT-2/PT-5	PT-2/PT-5	PT-2/PT-5	TR-1	PT-1	N/A	-	SEE INT. ELEV. FOR 2-COLOR WALLS
801	PENTHOUSE LEVEL 8	10'-4"	CL-5	PT-3	PT-3	PT-3	PT-3	TR-1	PT-2	N/A	-	-

COLOR AND MATERIAL SCHEDULE						
MARK	MATERIAL	MANUFACTURER	DESCRIPTION	DETAIL	REMARKS	
CL-1	LAY-IN ACOUSTIC PANEL CEILING	ARMSTRONG WORLD INDUST. INC.	2x4 FIGURED, SECOND LOOK II	BVA169	-	-
CL-2	ELEVATOR CAR CEILING	-	STAINLESS STEEL WITH PAINTED BLACK METAL FRAME	-	-	WITH (2) LV DOWN LIGHTS
CL-3	PAINT ON GYP. BD.	STATE APPROVED CONTRACT	PT-2	-	-	MAIN FLOOR LOBBY CEILING
CL-4	PAINT ON METAL PAN	STATE APPROVED CONTRACT	PT-3	-	-	PENTHOUSE LEVEL 8
CL-5	PAINT	BENJAMIN MOORE OR EQUAL	PT-3	-	-	ELEC. ROOM 1007 CEILING
CL-6	PAINT FREIGHT ELEV. CAR CEILING	BENJAMIN MOORE OR EQUAL	PT-3	-	-	-
PT-1	PAINT	BENJAMIN MOORE OR EQUAL	*460 (SILVER DOLLAR) MACHINE ROOM FLOORS	-	-	RM 1003, 1001
PT-2	PAINT	BENJAMIN MOORE OR EQUAL	*... (CAMEO WHITE) UPPER WALL COLOR	-	-	RM 1001, 1005, 1001 AND
PT-3	PAINT	BENJAMIN MOORE OR EQUAL	*458 (SILVER BELLS) MACHINE ROOM WALLS, DOOR FRAMES	-	-	*501-101 LOBBY WALLS - COLOR A
PT-4	PAINT	BENJAMIN MOORE OR EQUAL	*113 (OFF WHITE)	-	-	RM 1003, 1001 AND
PT-5	PAINT	BENJAMIN MOORE OR EQUAL	*119 (CELENTINE ROSE) LOWER WALL COLOR	-	-	RM 1001, 1005, 1001, 1001-101 AND
TR-1	RUBBER BASE	-	EXISTING TO REMAIN	-	-	HP1 DOOR FRAMES IN THESE ROOMS ONLY
FG-1	FLOOR CARPET	STATE APPROVED CONTRACT	LEES LEAVE 428 - MONROE	-	-	REPAIRS
FL-1	FLOOR TILE	EXISTING TILE TO REMAIN	CLEAN AND SEAL EXISTING TILE	-	-	REPAIRS
FL-1	CHECKER PLATE	ELEVATOR MANUF. STD. DESIGN	-	-	-	REPAIRS
FL-2	EXISTING PAINTED CONCRETE	BENJAMIN MOORE OR EQUAL	ALKYD FLOOR ENAMEL	-	-	REPAIRS

NOTE 1: COVER PLATES IN PAINTED CEILING AND HIGH WALLS ABOVE 1'-0" AFF. WILL BE BLIND, PLASTIC PLATES AND SHALL BE PAINTED TO MATCH THE SURROUNDING WALL/CEILING COLOR.  
NOTE 2: COVER PLATES BELOW 1'-0" AFF. ON THE WALL WILL BE STAINLESS STEEL.  
NOTE 3: COVER PLATES IN THE NEW LAY-IN ACOUSTIC TILE CEILING WILL BE WHITE TO MATCH THE TILES.  
NOTE 4: LOBBY BUMPER RAILS, SEE SPECS.



**jsa architects**  
architects  
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BUILDING NAME:

**OGDEN REGIONAL CENTER**

PROJECT TITLE:  
**OGDEN REGIONAL CENTER ELEVATOR MODERNIZATION**

**2540 WASHINGTON BOULEVARD ODGEN, UTAH 84401**

MARK	DATE	DESCRIPTION
XX-XX-XX	XXX	

ISSUE TYPE: CONSTRUCTION SET

ISSUE DATE: SEPTEMBER 14, 2009


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**INTERIOR ELEVATIONS**


SHEET NUMBER

**I- 204**


SHEET 13 OF 18

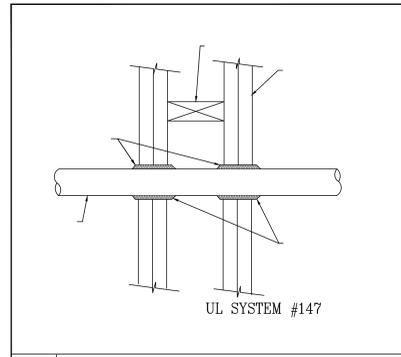


SCALE: N.T.S. FIRESTOP FOR METAL CONDUIT THROUGH GYPSUM WALL BOARD

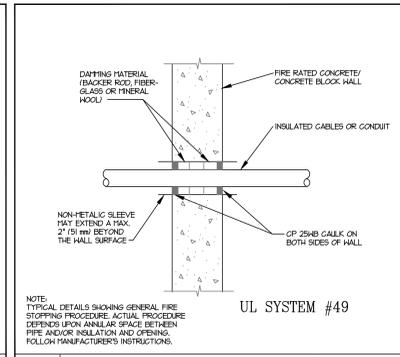

SCALE: N.T.S. TYPICAL FIRESTOP FOR CABLES/CONDUIT THROUGH CONCRETE WALLS

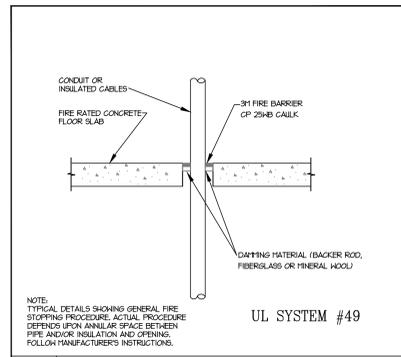


SCALE: N.T.S. TYPICAL FIRESTOP FOR CABLES/CONDUIT THROUGH CONCRETE FLOORING

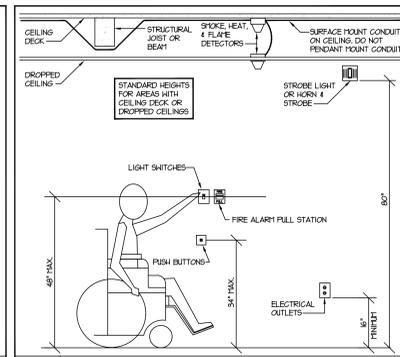


SCALE: N.T.S. STANDARD HEIGHTS FOR HANDICAPPED ACCESS

1. REPLACE THE EXISTING OUTLET WITH A GFI OUTLET IN THE ELEVATOR PIT. MAINTAIN THE CIRCUIT INTEGRITY TO THE EXISTING LIGHT IN THE ELEVATOR PIT.
2. REPLACE THE EXISTING OUTLET WITH A GFI OUTLET IN THE ELEVATOR EQUIPMENT ROOM.
3. PROVIDE A LOCKABLE DISCONNECT SWITCH ON A DEDICATED, 20 AMP, CIRCUIT BREAKER FOR THE ELEVATOR CART LIGHTING.
4. EXISTING LOCKABLE DISCONNECT SWITCH FOR THE ELEVATOR MOTOR SHALL REMAIN. PROVIDE AN AUXILIARY CONTACT IN THE DISCONNECT TO MONITOR THE POSITION OF THE DISCONNECT SWITCH. THIS SIGNAL WILL BE USED BY THE ELEVATOR CONTROL CONTRACTOR.
5. THE EXISTING SMOKE DETECTOR IN EACH ELEVATOR LOBBY ON EACH FLOOR SHALL REMAIN.
6. THE EXISTING SMOKE DETECTOR ON TOP OF THE ELEVATOR SHAFT SHALL REMAIN.
7. THE EXISTING HEAT DETECTOR ON TOP OF THE SHAFT AND HEAT DETECTOR WITHIN 24" OF EACH SPRINKLER HEAD IN THE ELEVATOR EQUIPMENT ROOM SHALL REMAIN.
8. THE EXISTING SMOKE DETECTOR IN ELEVATOR EQUIPMENT ROOM.
9. ALL ELEVATORS SHALL TRANSFER TO STANDBY POWER IN SEQUENCE, RETURN TO THE DESIGNATED LANDINGS AND DISCONNECT FROM THE EMERGENCY GENERATOR. AFTER ALL ELEVATORS HAVE BEEN RETURNED TO THE DESIGNATED LEVEL, AT LEAST ONE ELEVATOR SHALL REMAIN OPERABLE FROM THE EMERGENCY GENERATOR.
10. PROVIDE CONDUIT AND J-BOXES FOR ELEVATOR CAB PHONES. RUN THE CONDUIT TO T.T.B.

SCALE: N.T.S. ELEVATOR REQUIREMENTS

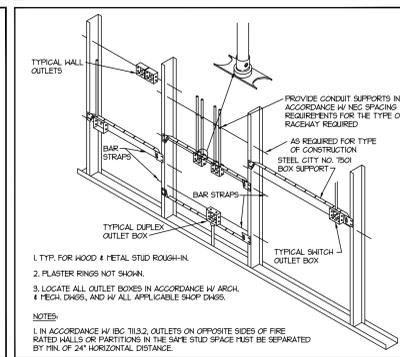

SCALE: N.T.S. TYPICAL ROUGH-IN REQUIREMENTS DETAIL

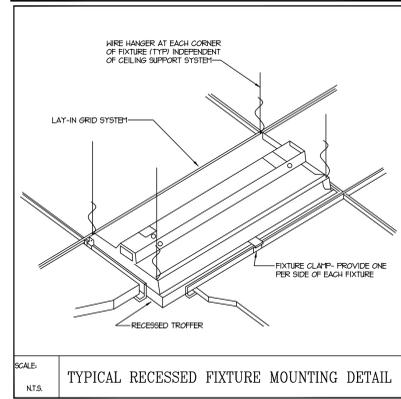

SCALE: N.T.S. TYPICAL RECESSED FIXTURE MOUNTING DETAIL

ABBREVIATIONS SYMBOL LIST	
SYMBOL	DESCRIPTION
A	INDICATES DEVICE IS ABOVE COUNTER TOP
AMP.	AMPERAGE
A.F.F.	ABOVE FINISHED FLOOR
C.L.S.	INDICATES CEILING MOUNTED DEVICE
C.O.	CONVENCE OUTLET
CU	COPPER
E	INDICATES DEVICE IS ON EMERGENCY CIRCUIT
(E)	INDICATES DEVICE IS EXISTING
F.A.C.P.	FIRE ALARM CONTROL PANEL
F.A.R.A.P.	FIRE ALARM REMOTE ANNUNCIATOR PANEL
F.A.N.E.P.	FIRE ALARM NETWORK EXPANDER PANEL
F.L.A.	FULL LOAD AMPERAGE
G.R.S.	GALVANIZED RIGID STEEL
H.P.	HORSE POWER
K.V.A.	KILO VOLT AMPERAGE
K.W.	KILOWATT
M.C.A.	MINIMUM CIRCUIT AMPERAGE
N.C.	NORMALLY CLOSED
N.O.	NORMALLY OPEN
O.T.R.	ON THE ROOF
S	INDICATES DEVICE IS SURFACE MOUNTED
TYP	TYPICAL

CONDUITS SYMBOL LIST	
SYMBOL	DESCRIPTION
---	CONDUITS CONCEALED IN FLOOR OR BELOW GRADE
---	CONDUITS CONCEALED IN CEILING AND WALLS
---	ARROWS INDICATE HOPE RUNS

MECHANICAL EQUIPMENT SCHEDULE					
NAME OF MECHANICAL EQUIPMENT	ELEVATOR				
	EV-1	EV-2	EV-3	EV-4	CARGO ELEVATOR
RATINGS/WATTS	480	480	480	480	
VOLTAGE	3	3	3	3	
AMPS	34.92	34.92	34.92	6.32	
WIRE SIZE	3#3	3#3	3#3	3#12	
GROUND WIRE	1#3	1#3	1#3	1#12	
CONDUIT SIZE	1-1/4"	1-1/4"	1-1/4"	3/4"	
FUSE DISC. SH.	100	100	100	30	
TYPE RFI FUSES	10	10	10	10	
NON-FUSE SH.	--	--	--	--	
CAPACITOR (KVAR)	--	--	--	--	
NOTES:	1. FINISH AND INSTALL N.O./N.C. CONTACTS IN EXISTING DISCONNECTS. TIE THE RELAY TO THE LOAD SIDE OF THE DISCONNECT.				

FIRE ALARM SYSTEMS SYMBOL LIST	
SYMBOL	DESCRIPTION
□	ELECTRICAL PANEL LOCATION
⊙	FIRE ALARM SYSTEM PHOTOELECTRIC SMOKE DETECTOR
⊙ <sub>0</sub>	FIRE ALARM PHOTOELECTRIC DUCT DETECTOR
⊙ <sub>h</sub>	FIRE ALARM HEAT DETECTOR
⊙ <sub>F</sub>	FIRE ALARM MANUAL PULL STATION, 42" AFF.
⊙ <sub>h</sub>	CEILING MOUNTED FIRE ALARM HORN WITH STROBE, HIGH DECIBEL, 46" AFF.
⊙ <sub>h</sub>	A.D.A. STROBE FOR FIRE ALARM, 46" AFF.
RM FAR	ADDRESSABLE RELAY CONTROL MODULE
MAG	MAGNETIC DOOR HOLDER
FSD	FIRE/SMOKE DAMPER
FAR	FIRE ALARM RELAY
AMM	ADDRESSABLE MONITOR MODULE
⊙	FIRE FIGHTERS TELEPHONE JACK

LIGHTING SYSTEMS SYMBOL LIST	
SYMBOL	DESCRIPTION
□	ELECTRICAL PANEL LOCATION
⊙	LAY-IN MOUNTED FLUORESCENT FIXTURE
⊙	SURFACE MOUNTED FLUORESCENT FIXTURE
⊙ <sub>E</sub>	EMERGENCY LIGHTING
⊙ <sub>ENL</sub>	EMERGENCY NIGHT LIGHT
⊙	PENDANT MOUNTED LIGHT FIXTURE - LENGTH AS SHOWN
⊙	EXIT LIGHT, ARROWS SHOW EXIT DIRECTION
⊙	DEVICES DRAWN WITH DIMMED LINES SHALL REMAIN
⊙	DEVICES DRAWN WITH DASHED LINES SHALL BE REMOVED

DISCONNECTS/CIRCUIT BREAKER SYMBOL LIST	
SYMBOL	DESCRIPTION
□	NON FUSED DISCONNECT SWITCH - SIZE AS REQUIRED
□	FUSED DISCONNECT SWITCH - SIZE AS REQUIRED
□	COMBINATION STARTER/FUSED DISCONNECT SWITCH - SIZE AS REQUIRED
□	CIRCUIT BREAKER DISCONNECT - SIZE AS REQUIRED
□	FUSE - SIZE AS REQUIRED
⊙	MOTOR LOCATION
□	ELECTRICAL PANEL LOCATION

COMMUNICATION SYSTEMS SYMBOL LIST	
SYMBOL	DESCRIPTION
□	TELEPHONE TERMINAL BOARD
⊙	FLUSH TELE/DATA OUTLET BY TELECOMMUNICATIONS CONTRACTOR

SECURITY SYSTEMS SYMBOL LIST	
SYMBOL	DESCRIPTION
⊙	CARD READER
⊙	CCTV CAMERA

- GENERAL NOTES:**
1. ALL MATERIALS TO BE REMOVED AND RETURNED TO THE OWNER. MATERIALS WHICH THE OWNER DECIDES NOT TO KEEP SHALL BE SALVAGED AND REMOVED FROM THE SITE BY THE CONTRACTOR.
  2. ALL CONCEALED CONDUIT THAT CANNOT BE REMOVED SHALL BE CUT FLUSH WITH THE FINISH SURFACES AND CAPPED OFF AFTER THE WIRING HAS BEEN DISCONNECTED AT THE PANEL AND REMOVED FROM THE CONDUIT.
  3. IN AREAS WHERE CIRCUIT CONTINUITY IS INTERRUPTED, BUT MUST BE MAINTAINED TO THE DEVICES WHICH ARE TO REMAIN MAKE ALL THE NECESSARY MODIFICATIONS TO THE CIRCUITS IN ORDER TO MAINTAIN THE CIRCUIT INTEGRITY.
  4. THE CONTRACTOR SHALL PATCH THE WALLS AND CEILINGS WHERE THE DEVICES ARE REMOVED TO MATCH THE EXISTING WALLS AND CEILINGS. COORDINATE WITH GENERAL CONTRACTOR.
  5. THE COLOR OF ALL THE EXISTING DEVICES AND COVERPLATES SHALL MATCH THE COLOR OF THE NEW DEVICES AND COVERPLATES. COORDINATE COLOR WITH ARCHITECT. PROVIDE NEW COVERPLATES FOR EXISTING DEVICES.
  6. REFER TO THE ARCHITECTURAL REFLECTED CEILING PLANS FOR THE EXACT LOCATION OF ALL LIGHTING FIXTURES.
  7. THE COLOR OF THE LIGHT FIXTURES SHALL BE SELECTED BY THE ARCHITECT.
  8. COORDINATE WITH THE OWNER AND ARCHITECT FOR THE EXACT LOCATION OF THE OUTLETS. PRIOR TO ROUGH-IN.
  9. PRIOR TO SUBMITTING A BID THE ELECTRICAL CONTRACTOR SHALL INSPECT THE SITE AND INCLUDE IN HIS BID PACKAGE ALL CHARGES DUE TO EXISTING CONDITIONS. SHOP DRAWINGS ARE REQUIRED. ALL LABOR MATERIAL AND WORKMANSHIP SHALL BE GUARANTEED FOR A PERIOD OF 1 YEAR FROM THE DATE OF ACCEPTANCE BY THE TENANT. REPLACE OR REPAIR ALL DEFECTS DURING THE GUARANTEED PERIOD.
  10. THE CONTRACTOR SHALL INFORM THE ARCHITECT/ENGINEER IN WRITING OF ANY DISCREPANCIES FOUND BETWEEN THE INTENDED FUNCTION OF EQUIPMENT AND EQUIPMENT SPECIFIED IN THE CONTRACT DOCUMENTS A MINIMUM OF FIVE (5) WORKING DAYS PRIOR TO ISSUANCE OF THE FINAL BID. FAILURE TO REPORT ANY DISCREPANCY (CATALOG NUMBERS, DISCONTINUED ITEMS, ETC.) DOES NOT RELIEVE THE CONTRACTOR FROM PROVIDING EQUIPMENT WHICH SHALL CONFORM TO AND FULFILL THE INTENT OF THE CONTRACT DOCUMENTS. NOR SHALL IT BE USED AS A CONDITION TO OBTAIN ADDITIONAL FUNDS FROM THE OWNER AFTER THE CONTRACT IS AWARDED. THE CONTRACTOR SHALL REQUEST ALL CLARIFICATIONS OF CONTRACT DOCUMENT REQUIREMENTS IN WRITING TO THE ARCHITECT/ENGINEER A MINIMUM OF FIVE (5) WORKING DAYS PRIOR TO ISSUANCE OF THE FINAL ADDENDUM.
  11. REFER TO THE ARCHITECTS SHEETS FOR THE EXACT LOCATION OF THE MECHANICAL EQUIPMENT.
  12. ELECTRICAL CONTRACTOR SHALL VERIFY ALL ELECTRICAL LOADS (VOLTAGE, PHASE, CONNECTION REQUIREMENT, ETC.) OF EQUIPMENT FURNISHED UNDER OTHER DIVISIONS WITH APPROVED SHOP DRAWINGS PRIOR TO BEGINNING ROUGH-IN.
  13. MINIMUM SIZE OF CONDUIT TO BE 3/4". ALUMINUM CONDUITS SHALL NOT BE USED.
  14. USE RIGID STEEL SET SCREW TYPE FITTINGS ONLY. DIE CAST FITTINGS SHALL NOT BE USED.
  15. RUN A NEUTRAL CONDUCTOR FOR EACH PHASE CONDUCTOR (EACH CIRCUIT) IN A CONDUIT. NOT MORE THAN THREE (3) CIRCUITS IN A CONDUIT. THREE (3) PHASE CONDUCTORS, THREE (3) NEUTRAL CONDUCTORS (ONE FOR EACH PHASE) AND ONE (1) GROUND CONDUCTOR FOR A TOTAL OF SEVEN (7) CONDUCTORS.
  16. THE SIZE OF THE NEUTRAL CONDUCTORS SHALL BE NO. 10 AWG FOR ALL HORN HORN WITH COMMON NEUTRAL (LIGHTING AND POWER CIRCUITS).
  17. FOR SPECIFICATION OF RIGID WIRES IN EMPTY CONDUITS, REFER TO THE ELECTRICAL SPECIFICATION FOR RACEWAYS.
  18. THE MINIMUM SIZE OF THE CONDUCTORS ARE TO BE #12 AWG THIN COPPER, UNLESS INDICATED OTHERWISE ON THE DRAWINGS.
  19. ALL J-BOXES SHALL HAVE MINIMUM DEPTH OF 2-1/8" UNLESS OTHERWISE SPECIFIED. SECURE ALL J-BOXES AS SHOWN IN THE DETAILS. FURNISH AND INSTALL PROPER RUD RINGS.
  20. ALL NEW EXPOSED CONDUIT MUST RUN AGAINST THE WALLS OR CEILINGS. DO NOT PENDANT POINT ANY CONDUIT FROM THE CEILING.
  21. AT THE END OF THE JOB, PROVIDE BLANK COVER PLATES TO MATCH THE OTHER COVER PLATES FOR ALL J-BOXES WHERE DEVICES HAVE NOT YET BEEN INSTALLED.
  22. SEAL AROUND ALL CONDUIT PENETRATIONS THROUGH FIRE RATED WALLS AND CEILINGS WITH FIRE RATED MATERIAL. 3" IS AN APPROVED MANUFACTURER.
  23. ALL ELECTRICAL WIRING MUST BE IN CONDUIT (RPMX AND PVC CABLE NOT PERMITTED).
  24. FLEXIBLE CONDUITS CAN ONLY BE USED FOR SHORT RUNS (6' MAXIMUM).
  25. NO CONDUITS SHALL RUN IN DUCT WORK.
  26. THE ELECTRICAL CONTRACTOR SHALL TERMINATE THE ELECTRICAL CONNECTIONS TO ALL THE EQUIPMENT BY PROVIDING THE NECESSARY MALE/FEMALE CONNECTOR, RECEPTACLE, PLUG, ETC.
  27. PROVIDE TYPED LABEL FOR ALL DUPLEX OUTLETS AND LIGHT SWITCHES TO INDICATE WHICH CIRCUIT THEY ARE TIED TO.
  28. ALL DUPLEX OUTLETS SHALL BE 20 AMP, 120 VOLT SPEC GRADE. HUBBELL AND PASS & SEYMOUR AND LEVITON ARE APPROVED MANUFACTURERS.
  29. FOR ALL INCANDESCENT LIGHT FIXTURES ISO C RATED CONDUCTORS ARE REQUIRED.
  30. INSTALL EXIT SIGNS ON THE HALL, IF POSSIBLE.
  31. USE EPOXY ANCHORS TO SUPPORT THE ELECTRICAL EQUIPMENT. EXPANSION ANCHOR BOLTS ARE NOT ACCEPTED.
  32. PROVIDE UPDATED, TYPED WRITTEN PANEL SCHEDULES FOR NEW AND EXISTING PANELBOARDS SHOWING CIRCUIT CHANGES MADE DURING THIS PROJECT.
  33. ALL DISCONNECTS SHALL BE HEAVY DUTY TYPE.
  34. ALL MAGNETIC DOOR HOLDERS SHALL BE TIED TO THE FIRE ALARM CONTROL PANEL. IN THE EVENT OF A FIRE ALARM THE DOOR HOLDERS SHALL BE DE-ENERGIZED AND RELEASE THE DOORS. PROVIDE ALL CONDUIT, WIRE, JUNCTION BOXES, ETC. FOR A COMPLETE INSTALLATION. REFER TO THE ELECTRICAL AND ARCHITECTURAL FLOOR PLANS FOR THE EXACT LOCATIONS OF THE DOOR HOLDERS.
  35. TO MINIMIZE NUMBER OF FALSE FIRE ALARM DURING CONSTRUCTION, THE CONTRACTOR SHALL CAP SMOKE DETECTORS IN AREAS ADJACENT TO WORK SITE WHILE DUST-GENERATING WORK IS PERFORMED. THESE CAPS SHALL BE REMOVED AT END OF WORKDAY. A LOG SHALL BE KEPT SHOWING THAT ALL CAPS ARE REMOVED AND ACCOUNTED FOR.
  36. IF, FOR ANY REASON FIRE ALARM SYSTEM CANNOT BE RETURNED TO SERVICE AT THE END OF WORK DAY, CONTRACTOR SHALL PROVIDE FIRE WATCH AT NO ADDITIONAL COST TO THE OWNER.
  37. UPDATE THE BUILDING FIRE ALARM SCHEMATIC DRAWINGS TO SHOW LOCATIONS OF NEW AND EXISTING FIRE ALARM DEVICES CHANGED DURING THIS PROJECT. FIRE ALARM SYSTEM SHALL BE TESTED FOR PROPER OPERATION AT THE END OF THE PROJECT. ALL TESTS AND REPORTS SHALL BE COMPLIANT WITH NFPA 12 CHAPTER 7. COORDINATE TESTING WITH THE OWNER AND FIRE MARSHALL.
  38. PAINT ALL THE J-BOXES FOR FIRE ALARM SYSTEM WITH RED PAINT. ALL THE CONDUIT FOR FIRE ALARM SYSTEM SHALL BE RED.
  39. ANY CIRCUIT BREAKER FEEDING FIRE ALARM SYSTEMS SHALL CONTAIN RED MARKING AND SHALL BE LABELED FOR FIRE ALARM SYSTEM.
  40. ALL NEW WORK MUST MEET THE CURRENT ADOPTED NATIONAL ELECTRICAL CODE.
  41. ALL MATERIALS USED IN THIS INSTALLATION SHALL BE UL APPROVED AND NEW.
  42. TEMPORARY ELECTRICAL SERVICE IS TO BE PROVIDED BY THE ELECTRICAL CONTRACTOR AND REMOVED BY THE ELECTRICAL CONTRACTOR.
  43. DETAILS ARE SHOWN ON DIFFERENT SHEETS. THE CONTRACTOR SHALL REFER TO THOSE DETAILS WHETHER OR NOT CALLED IN REFERENCE NOTES.
  44. CONTRACT DOCUMENTS SHALL TAKE PRECEDENCE OVER SHOP DRAWINGS UNLESS SPECIFICALLY NOTED OTHERWISE.

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BUILDING NAME:  
**OGDEN REGIONAL CENTER**

PROJECT TITLE:  
**OGDEN REGIONAL CENTER ELEVATOR MODERNIZATION**  
**2540 WASHINGTON BOULEVARD OGDEN, UTAH 84401**

MARK	DATE	DESCRIPTION

ISSUE TYPE: FINAL REVIEW SET

ISSUE DATE: SEPTEMBER 14, 2009

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ECE PROJECT NO: 3853  
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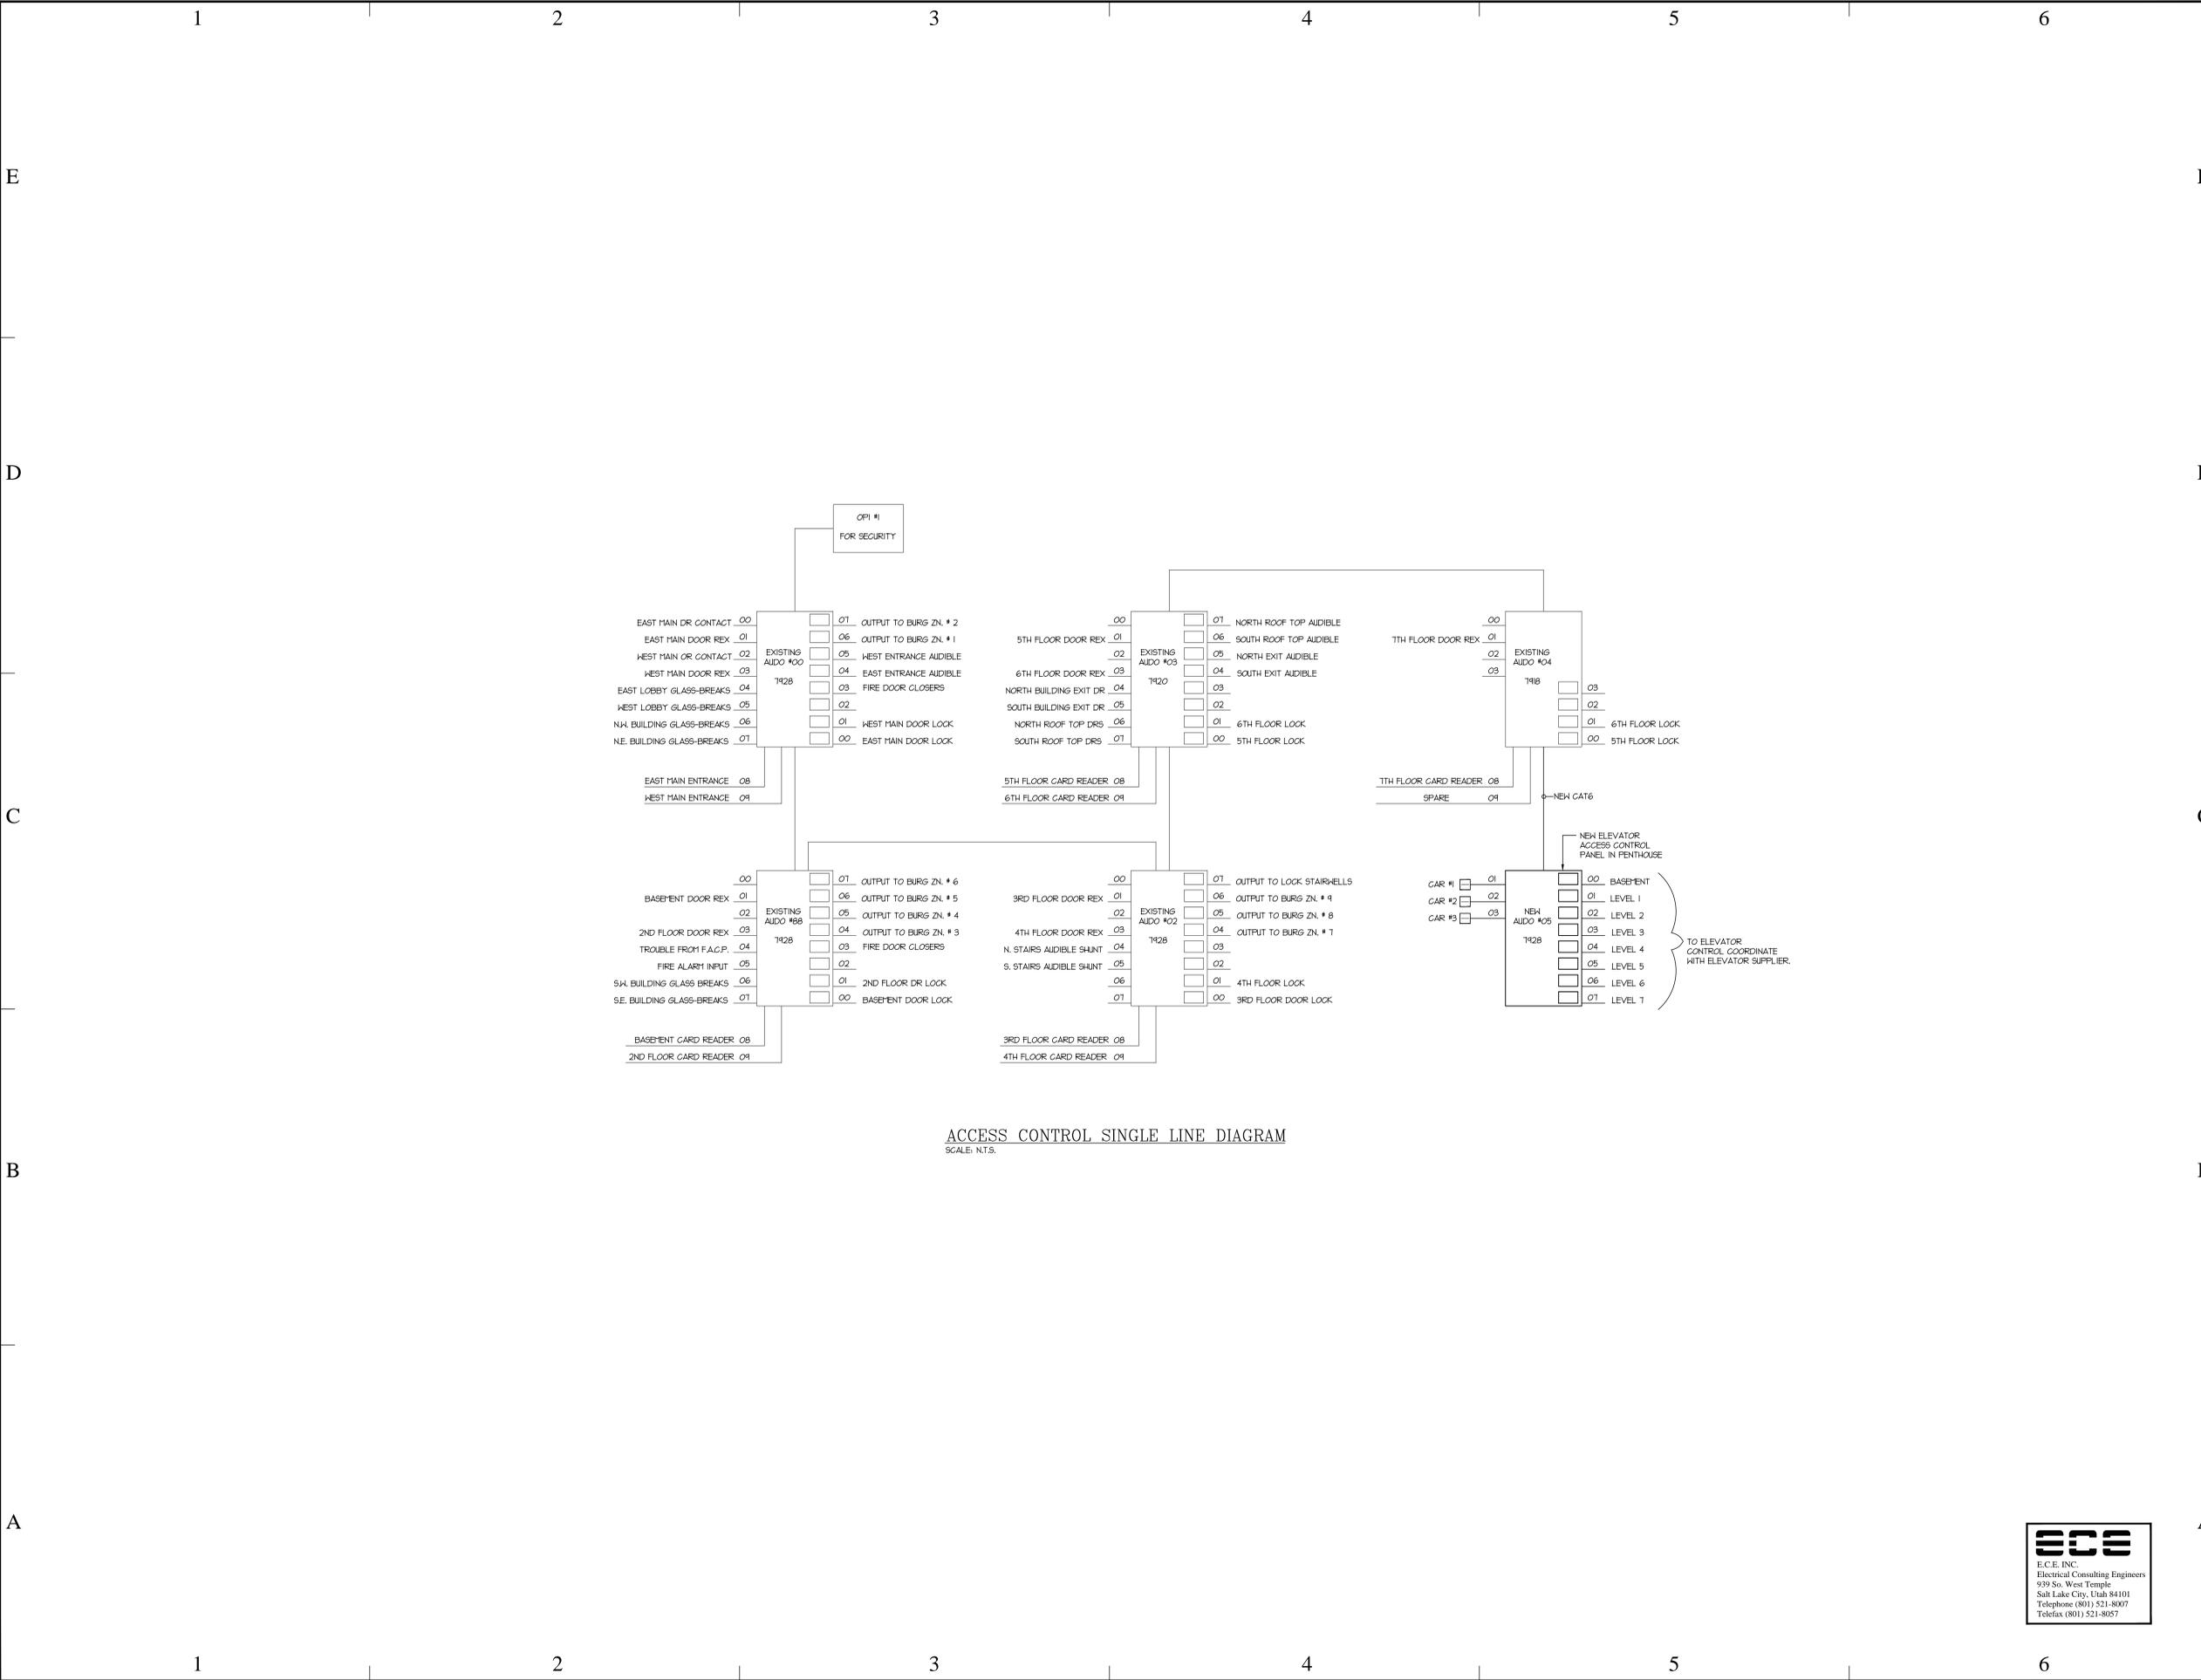
SHEET TITLE

**GENERAL NOTES AND SCHEDULES**

SHEET NUMBER

**EE-01**

SHEET 14 OF 18



ACCESS CONTROL SINGLE LINE DIAGRAM  
SCALE: N.T.S.



architects  
planners  
interior designers

6465 South 3000 East  
Suite 205  
Salt Lake City, UT 84121  
Ph: 801.733-2500  
Fax: 801.733-2501  
www.jsa-lc.com

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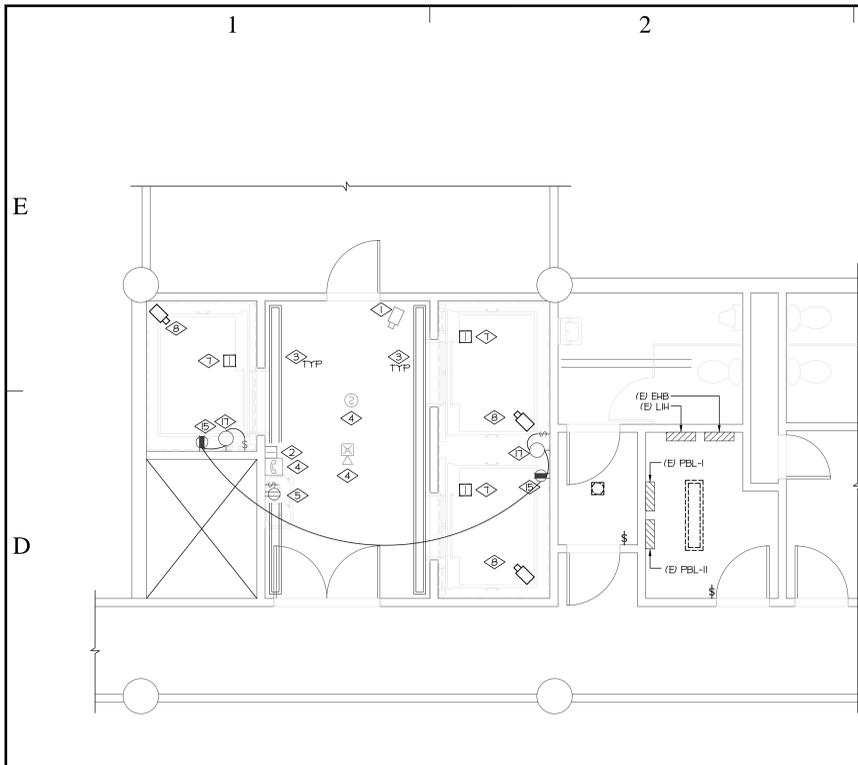
ACCESS CONTROL SINGLE LINE DIAGRAM

SHEET NUMBER

EE-02

SHEET 15 OF 18






PARTIAL BASEMENT FLOOR PLAN - ELECTRICAL

SCALE = 1/4" = 1'-0"


EE-101

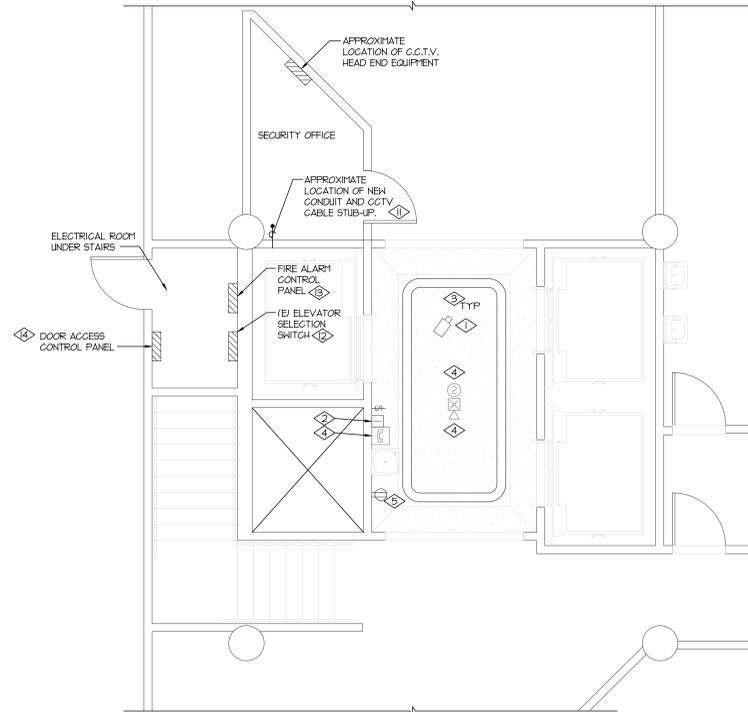

PARTIAL FIRST FLOOR PLAN - ELECTRICAL

SCALE = 1/4" = 1'-0"


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PARTIAL SECOND FLOOR PLAN - ELECTRICAL

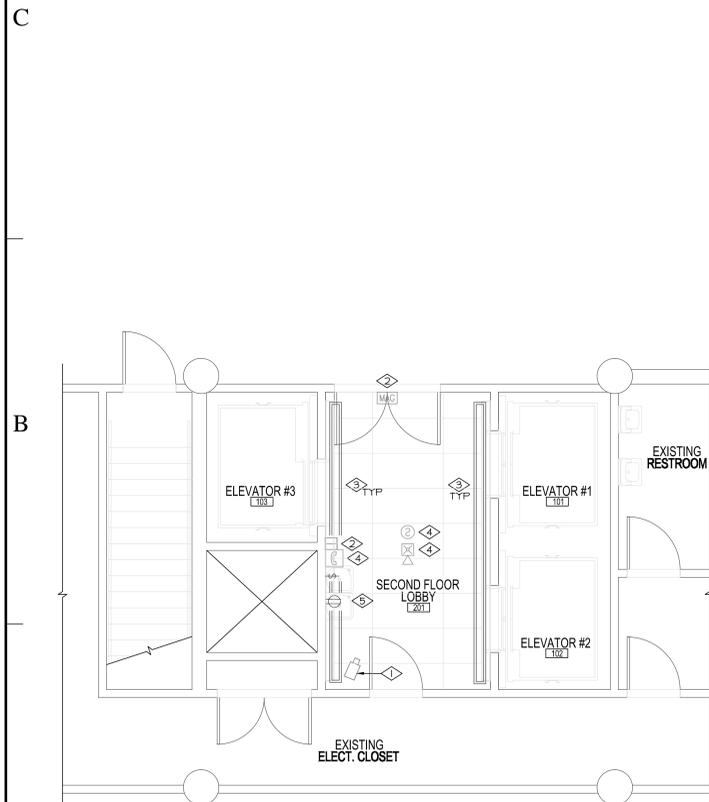SCALE = 1/4" = 1'-0"


EE-101



PARTIAL THIRD FLOOR PLAN - ELECTRICAL

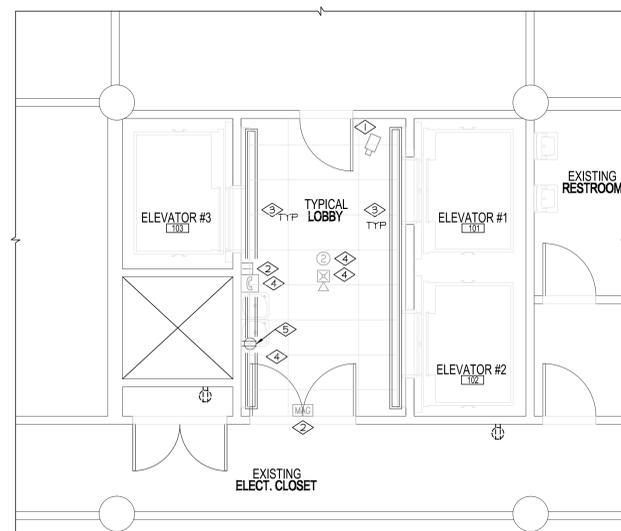SCALE = 1/4" = 1'-0"

EE-101

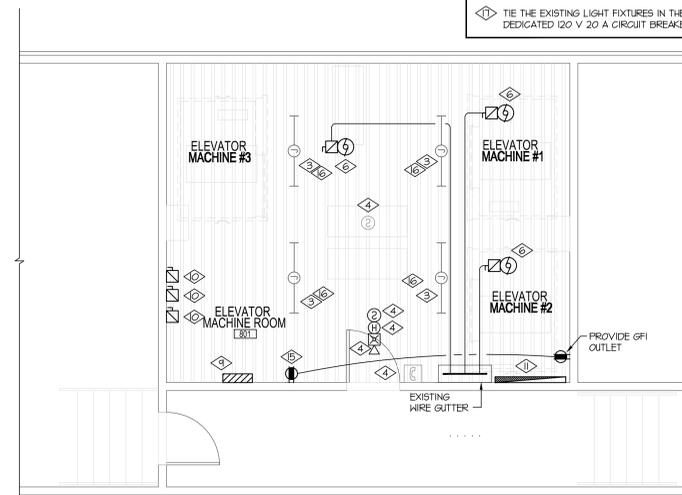

PARTIAL PENTHOUSE FLOOR PLAN - ELECTRICAL

SCALE = 1/4" = 1'-0"

EE-101



- REFERENCE NOTES:**
- ◇ EXISTING SECURITY CAMERA SHALL REMAIN. MAINTAIN CIRCUIT INTEGRITY.
  - ◇ EXISTING ACCESS CONTROL DEVICE SHALL REMAIN. MAINTAIN CIRCUIT INTEGRITY.
  - ◇ EXISTING LIGHT FIXTURE SHALL REMAIN. PROTECT, REMOVE, STORE, AND REINSTALL FIXTURE AT THE SAME LOCATION WHILE THE CEILING IS BEING REPLACED. CLEAN AND RE-LAMP ALL EXISTING FIXTURES TO REMAIN.
  - ◇ EXISTING FIRE ALARM DEVICE SHALL REMAIN. REMOVE, STORE AND REINSTALL WHILE EXISTING CEILING IS BEING REPLACED. PROTECT DEVICES AGAINST DAMAGE. MAINTAIN CIRCUIT INTEGRITY.
  - ◇ EXISTING ELECTRICAL DEVICE TO REMAIN. MAKE ANY MODIFICATIONS NECESSARY TO MAINTAIN CIRCUIT INTEGRITY. PROVIDE A NEW COVERPLATE TO MATCH NEW DEVICES. COORDINATE COLORS WITH ARCHITECT.
  - ◇ EXISTING ELEVATOR MACHINES SHALL BE REPLACED. DISCONNECT THE NEW ELEVATOR MACHINES TO THE EXISTING CIRCUITS. PROVIDE ALL NECESSARY CONDUIT, CONDUCTORS, J-BOXES, CONNECTIONS, ETC. TO EXTEND CIRCUIT AND COMPLETELY INSTALL THE NEW MACHINES. DISCONNECT AND REMOVE ALL UNUSED CONDUIT, CONDUCTORS, J-BOXES, ETC. DISCONNECTS SHALL BE REUSED. PROVIDE AN AUXILIARY CONTACT TO MONITOR THE POSITION OF THE DISCONNECT. COORDINATE WITH ELEVATOR CONTRACTOR FOR ALL CONNECTION REQUIREMENTS.
  - ◇ FURNISH AND INSTALL A NEW PROXIMITY CARD READER IN THE ELEVATOR CAB. THE CARD READER SHALL RESTRICT FLOOR ACCESS TO QUALIFIED PERSONNEL. COORDINATE WITH THE ELEVATOR SUPPLIER SO THAT THE ELEVATOR IS PROVIDED WITH CARD ACCESS READER ROUGH-IN, SPACE FOR SECURITY WIRING IN THE ELEVATOR CABLE ASSEMBLY, PROGRAMMING ETC. PROVIDE ADDITIONAL SECURITY EXPANSION CARDS IN THE SECURITY CONTROL PANEL TO ACCOMMODATE THE NEW READERS. PROVIDE ALL CONDUCTORS, J-BOXES, CONDUITS, PROGRAMMING ETC. NECESSARY FOR A COMPLETE INSTALLATION. COORDINATE THE EXACT LOCATION AND ELEVATION OF THE CARD READER WITH ARCHITECT. PROVIDE DEVICES COMPATIBLE WITH THE EXISTING TAG-NET SECURITY SYSTEM. REFER TO SPECIFICATION FOR MORE REQUIREMENTS.
  - ◇ FURNISH AND INSTALL 4"X4"X2" DEEP FLUSH J-BOX WITH SINGLE GANG HUBBERS FOR FUTURE CCTV CAMERA IN THE ELEVATOR CAB. COORDINATE WITH THE ELEVATOR SUPPLIER SO THAT THE ELEVATOR IS PROVIDED WITH CAMERA ROUGH-IN. PROVIDE A SHIELDED CAT-6 AND AN RSI CABLE IN THE TRAVELING CABLE FROM THE CAMERA ROUGH-IN IN THE ELEVATOR CAR TO THE NEW T.I.B. IN THE ELEVATOR PENTHOUSE. PROVIDE ALL J-BOXES, CONDUITS, ETC. NECESSARY FOR A COMPLETE INSTALLATION. COORDINATE THE EXACT LOCATION AND ELEVATION OF THE CCTV ROUGH-IN WITH ARCHITECT.
  - ◇ FURNISH AND INSTALL A NEW ACCESS CONTROL PANEL FOR THE ELEVATOR CABS CARD READERS. TIE TO THE EXISTING ACCESS CONTROL PANEL ON THE SEVENTH FLOOR. RUN CONDUCTORS FROM THE SEVENTH FLOOR TO THE PENTHOUSE IN THE ELEVATOR RACKWAY. ACCESS CONTROL PANEL SHALL BE COMPATIBLE WITH THE EXISTING ACCESS CONTROL PANEL. COORDINATE WITH THE ELEVATOR SUPPLIER FOR DETAILS AND REQUIREMENTS TO CONTROL THE ELEVATOR DOORS.
  - ◇ FURNISH AND INSTALL A 20A DISCONNECT FOR ELEVATOR CAR LIGHTING. TIE TO A SPARE 20A CIRCUIT BREAKER IN LIFE SAFETY PANEL "E8B" IN THE SEVENTH FLOOR ELECTRICAL ROOM.
  - ◇ FURNISH AND INSTALL A 4"X4"X3/4" FIRE TREATED, FLYWOOD BOARD FOR FUTURE CAMERA EQUIPMENT. RUN ONE (1) RGIU CABLE AND ONE SHIELDED CAT-6 PLENUM RATED CABLE TO THE CCTV HEAD END IN THE SECURITY OFFICE THROUGH THE ELEVATOR RACKWAY IN THE ELEVATOR SHAFT. RUN 3/4" CONDUIT FROM THE SHAFT INTO THE OFFICE.
  - ◇ TIE THE EXISTING ELEVATOR SELECTOR SWITCH TO THE NEW ELEVATOR CONTROLS. COORDINATE EXACT CONNECTION REQUIREMENTS WITH ELEVATOR INSTALLER. PROVIDE ALL CONDUCTORS NECESSARY. UTILIZE EXISTING CONDUIT.
  - ◇ EXISTING SILENT KNIGHT 5885 XL FIRE ALARM PANEL TO REMAIN. PROVIDE ALL HARDWARE, SOFTWARE, PROGRAMMING AND LABOR NECESSARY TO DISCONNECT THE OLD ELEVATOR AND TIE THE FIRE ALARM SIGNALS TO THE NEW ELEVATOR CONTROLLER. RE-CERTIFY THE FIRE ALARM SYSTEM AT THE END OF THE PROJECT.
  - ◇ EXISTING TAG-NET MODEL 40UP-T30 CONTROL PANEL TO REMAIN. PROVIDE ALL HARDWARE, SOFTWARE, PROGRAMMING AND LABOR NECESSARY TO ACCOMMODATE THE NEW CARD READERS POST NEW ACCESS CONTROLS RISER DIAGRAMS ON THE DOOR OF THE PANEL SHOWING THE NEW ACCESS CONTROL PANEL AND ITS DEVICES.
  - ◇ REPLACE THE EXISTING OUTLET WITH A GFI DEVICE. TIE THE OUTLET TO THE UNSWITCHED LIGHTING CIRCUIT IN THE ROOM.
  - ◇ TIE THE EXISTING LIGHT FIXTURES IN THE ELEVATOR MACHINE ROOM TO AN AVAILABLE 120V 20A CIRCUIT BREAKER IN PANEL "E8B"
  - ◇ TIE THE EXISTING LIGHT FIXTURES IN THE ELEVATOR PIT TO A DEDICATED 120 V 20 A CIRCUIT BREAKER IN PANEL "L1H"

**DEMOLITION NOTES:**  
 1. CONTRACTOR SHALL PROTECT AGAINST DAMAGE ALL DEVICES INDICATED TO REMAIN. DEVICES DAMAGED SHALL BE REPLACED OR REPAIRED BY CONTRACTOR AT NO ADDITIONAL EXPENSE TO THE OWNER.



6465 South 3000 East  
 Suite 205  
 Salt Lake City, UT 84121  
 Ph: 801.733.2500  
 Fax: 801.733.2501  
 www.jsa-lc.com

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OGDEN REGIONAL CENTER

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 OGDEN, UTAH 84401

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SHEET TITLE

FLOOR PLANS - ELECTRICAL


SHEET NUMBER

EE-101

SHEET 16 OF 18




E.C.E. INC.  
 Electrical Consulting Engineers  
 939 So. West Temple  
 Salt Lake City, Utah 84101  
 Telephone (801) 521-8007  
 Telefax (801) 521-8057

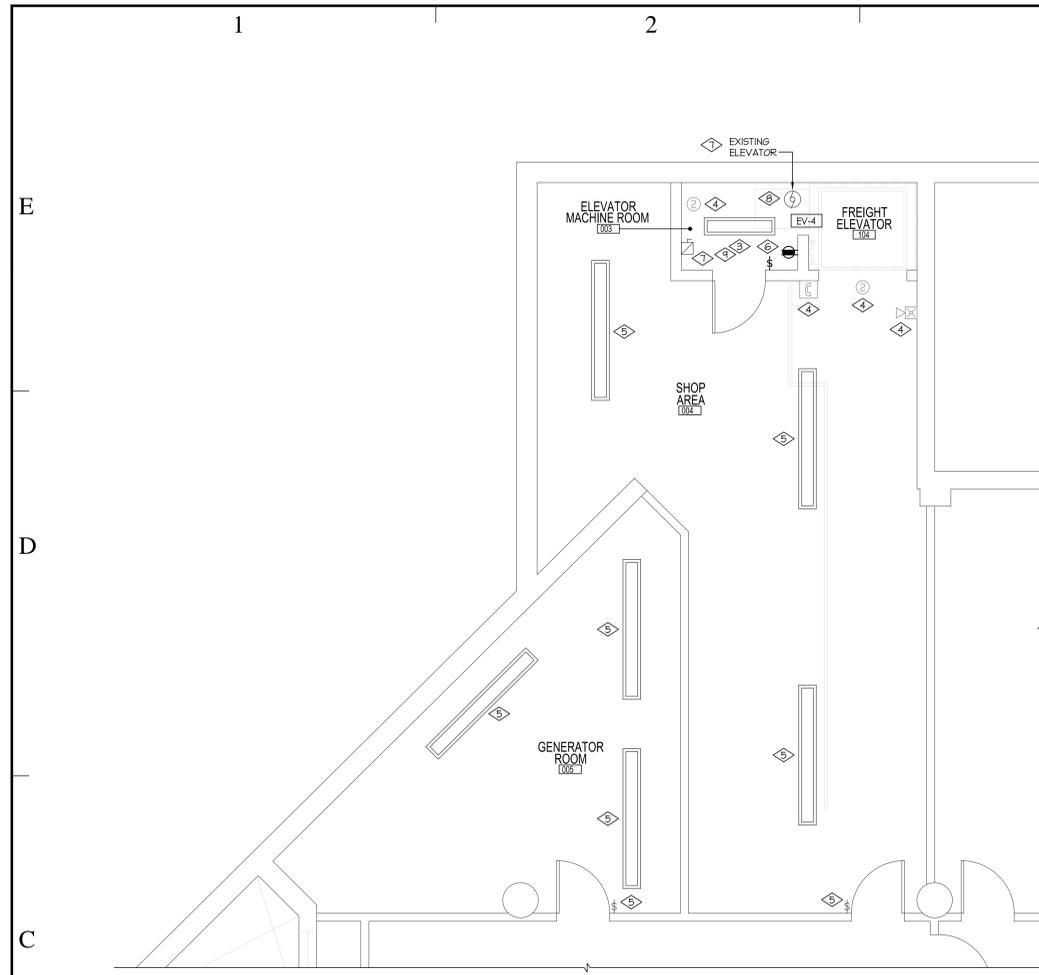

PARTIAL BASEMENT FLOOR PLAN - ELECTRICAL

SCALE: 1/4"=0'

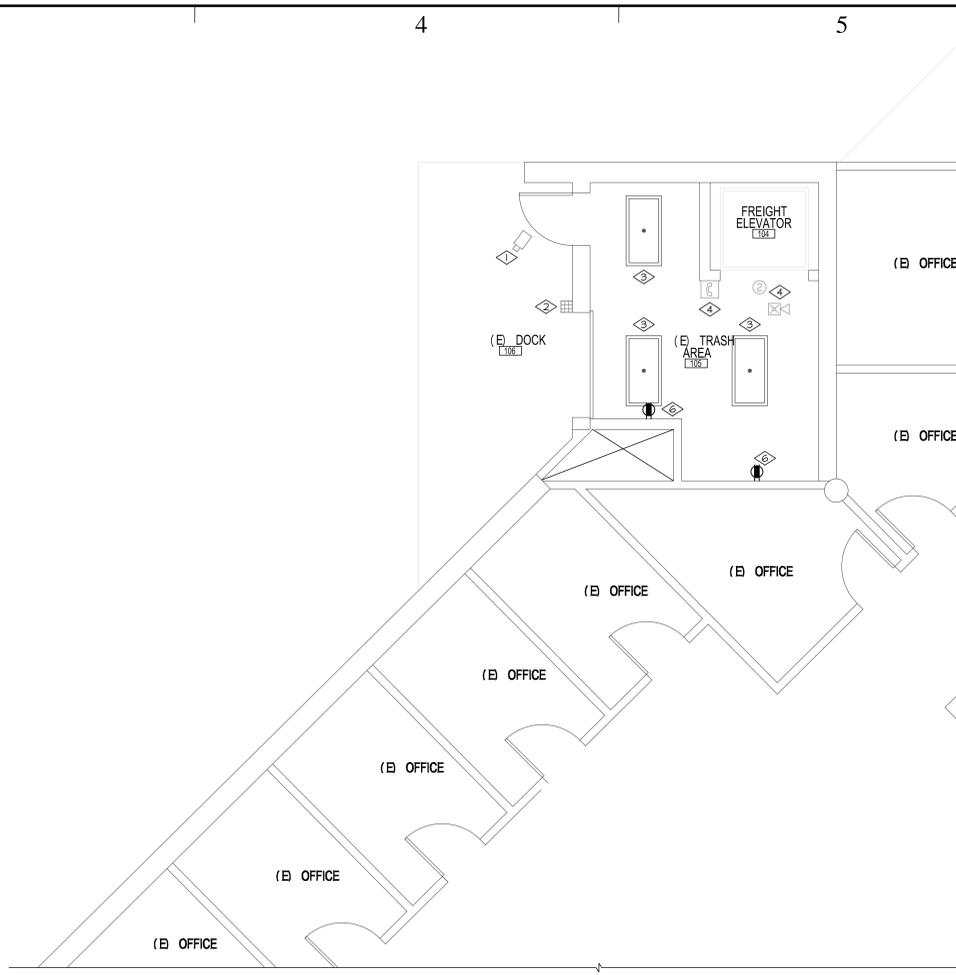


PARTIAL FIRST FLOOR - ELECTRICAL

SCALE: 1/4"=0'



- REFERENCE NOTES:**
- ① EXISTING SECURITY CAMERA SHALL REMAIN. MAINTAIN CIRCUIT INTEGRITY.
  - ② EXISTING ACCESS CONTROL DEVICE SHALL REMAIN. MAINTAIN CIRCUIT INTEGRITY.
  - ③ STORE AND REINSTALL FIXTURE AT THE SAME LOCATION WHILE THE CEILING IS BEING REPLACED. CLEAN AND RE-LAMP ALL EXISTING FIXTURES TO REMAIN.
  - ④ EXISTING FIRE ALARM DEVICE SHALL REMAIN. MAINTAIN CIRCUIT INTEGRITY.
  - ⑤ CLEAN AND RELAMP EXISTING LIGHT FIXTURES.
  - ⑥ EXISTING OUTLETS SHALL BE REPLACED WITH GFI OUTLETS. PROVIDE NEW COVER PLATES. TIE TO THE ROOM'S UNSWITCHED LIGHTING CIRCUIT.
  - ⑦ EXISTING ELEVATOR MACHINE SHALL BE REPLACED. CONNECT THE NEW ELEVATOR MACHINES TO THE EXISTING CIRCUITS. PROVIDE ALL NECESSARY CONDUIT, CONDUCTORS, J-BOXES, CONNECTIONS ETC. NECESSARY. EXTEND AND COMPLETELY DISCONNECT.
  - ⑧ TIE THE NEW CARGO ELEVATOR TO THE CIRCUIT MADE AVAILABLE DURING THE DEMOLITION OF THE EXISTING ELEVATOR. PROVIDE ALL CONDUITS, CONDUCTORS, J-BOXES, ETC. NECESSARY FOR A COMPLETE INSTALLATION.
  - ⑨ TIE THE EXISTING LIGHT FIXTURES IN THE ELEVATOR MACHINE ROOM TO AN AVAILABLE 120V 20A CIRCUIT BREAKER IN PANEL 'E4B'

- DEMOLITION NOTES:**
- I. CLEAN AND RELAMP ALL LIGHT FIXTURES INDICATED TO REMAIN.

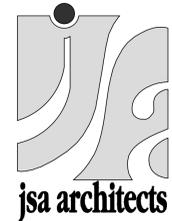

architects  
planners  
interior designers

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Suite 205  
Salt Lake City, UT 84121  
Ph: 801.733.2500  
Fax: 801.733.2501  
www.jsa-lc.com

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MODERNIZATION

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SHEET TITLE

FLOOR PLANS -  
ELECTRICAL

SHEET NUMBER

EE-102

SHEET 17 OF 18



